
630 4TH AVE S APARTMENTS

630 4TH AVENUE SOUTH, ST. PETERSBURG, FL 33701

PERMIT SET

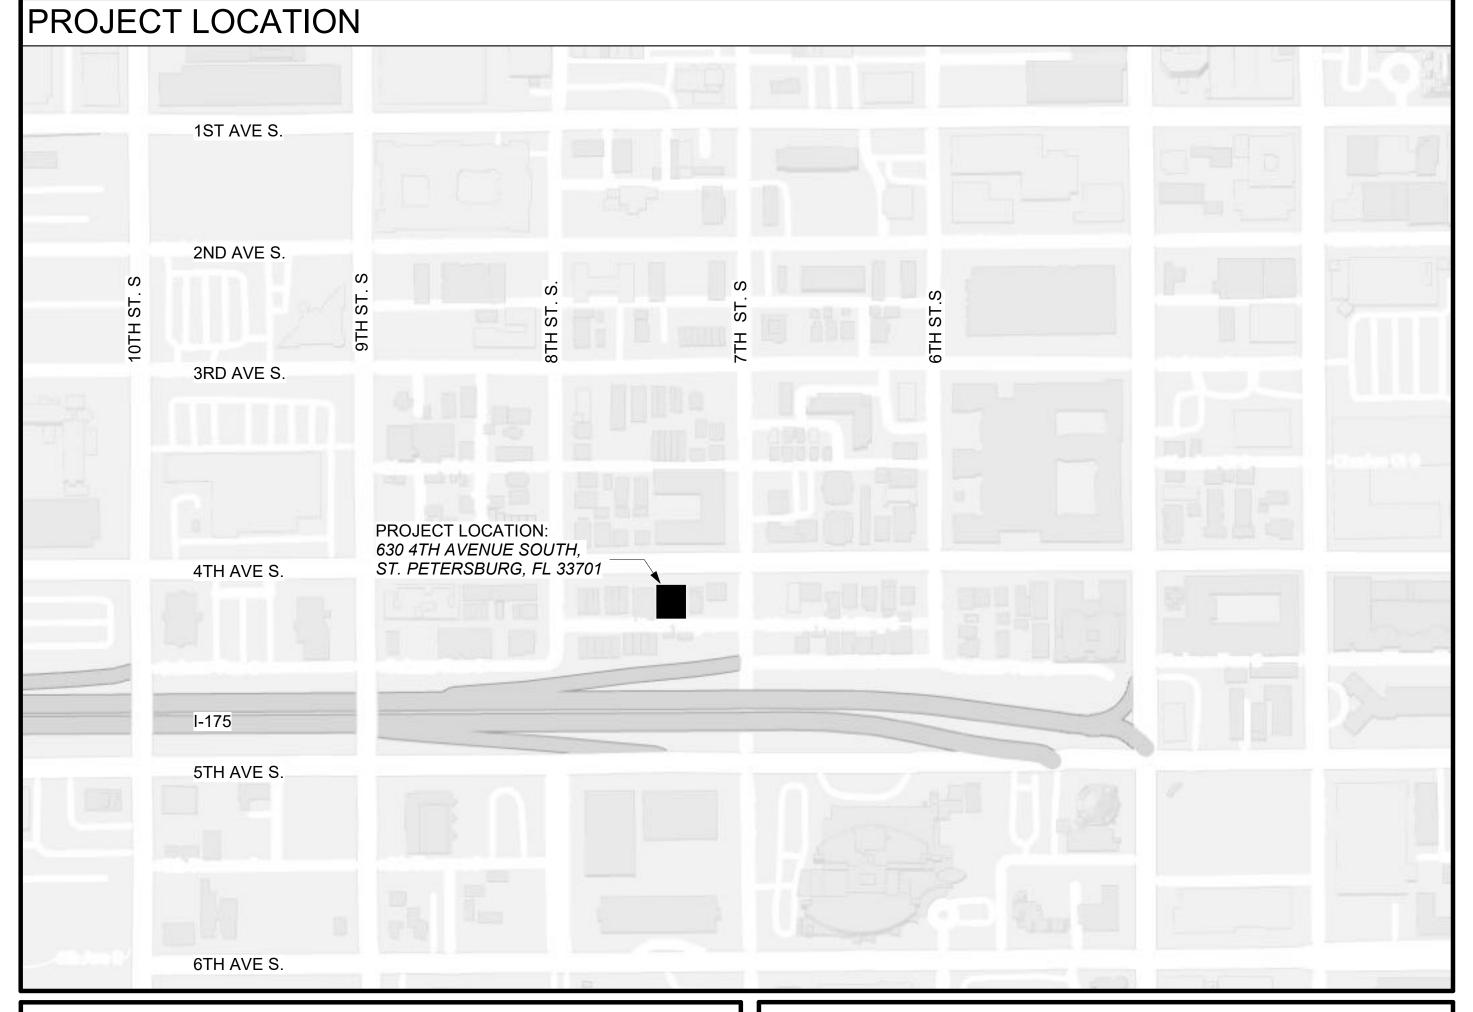





BUILDING DATA

ZONING 1. ZONING DISTRICT DO (CONTACT OF A CONTACT OF A

DC-2 (DOWNTOWN CENTER)

BONUS APPROVAL, STREAMLINE (FAR) GREATER THAN 3.0 AND EQUAL TO OR LESS THAN 5.0 REQUIRED

MASSING & FORM:
SETBACKS ALONG STREET, EXCLUDING ALLEYS

0 TO 50 FT HIGH: 0 FT. ABOVE 50 FT: 10 FT.

EXEMPTIONS: WHEN BUILDINGS HAVE A FIRST FLOOR PLATE OF LESS THAN 16,000 SQ. FT., THE 10-FOOT SETBACK ABOVE 50 FT IS NOT REQUIRED. DISTANCES BETWEEN BUILDINGS:

A. BLANK WALL TO BLANK WALL, UP TO 50 FT. HIGH - 0 FT.
B. WINDOW WALL TO WINDOW WALL UP TO 50 FT. HIGH - 15 FT.

C. ALL CONDITIONS 50 FT. TO 200 FT. HIGH - 60 FT.

FOR ALL CONDITIONS ABOVE 50 FT. ON LOTS OF RECORD WITH AN AVERAGE LOT WIDTH EQUAL TO OR LESS THAN 120 FT., THE PROPERTY SHALL QUALIFY FOR A REDUCED MINIMUM INTERIOR BUILDING SETBACK FROM EACH INTERIOR, SHARED PROPERTY LINE. THE REDUCED SETBACK SHALL BE EQUAL TO 25% OF THE LOT WIDTH, OR 15 FEET, WHICHEVER IS GREATER. THIS SETBACK SHALL BE MEASURED FROM THE INTERIOR, SHARED PROPERTY LINE.

THIS PROJECT IS PERMITTED THE ADDITIONAL 12-FEET IN HEIGHT PLUS THE 50-FEET BEFORE THE DISTANCE BETWEEN BUILDINGS SHALL OCCUR AS THE FIRST FLOOR PROVIDES FOR OVER 50% OF PARKING.

SETBACK PROVIDED FROM PROPERTY LINE (MEASURED TO FACE OF STRUCTURE UP TO 62' FT.)

- 0'-4" ON NORTH STREET FACING SIDE (0'-0" REQUIRED)

- 7'-6" ON WEST AND 7'-7" ON EAST (7'-6" REQUIRED)

STEPBACK PROVIDED FROM PROPERTY LINE (MEASURED TO FACE OF STRUCTURE ABOVE 62' FT.)
- 0'-6" ON NORTH STREET FACING SIDE (0'-0" REQUIRED)
- 22'-6" ON WEST AND 22'-7" EAST (22'-6" REQUIRED)
- 23'-0" ON SOUTH (14'-0" R.O.W. MEANS 60 FT. DISTANCE BETWEEN BUILDINGS AT ALLEY)

PTIONS: PET CAN ENCROACH 4 FT. AND STAIRS, ELEVATOR AND MECHANICAL TOWERS CAN ENCRO

4. USE PERMISSIONS AND PARKING REQUIREMENTS.
VEHICLE PARKING: DWELLING, MULTIFAMILY: MORE THAN 750 SQUARE FEET: 1 PER UNIT; EQUAL TO OR LESS

- 10'-8" ON SOUTH (0'-6" REQUIRED)

THAN 750 SQUARE FEET: ZERO (0) PER UNIT.

REQUIRED: 33 TOTAL UNITS - 22 UNITS UNDER 750 SF = 11 SPACES

1 ADA SPACE REQUIRED PER FBC ACCESIBILITY TABLE 208.2

15% EV AND 2% EVSE SPACES REQUIRED = 2 SPACES

PROVIDED: 16 (INCLUDING 1 ADA SPACE)

ONG TERM BICYCLE PARKING: RESIDENTIAL, MULTIFAMILY: 1 PER EACH UNIT REQUIRED: 33 SPACES

PROVIDED: 33 (1 PER UNIT) + 5 SURFACE LEVEL = 38
SHORT TERM BICYCLE PARKING: RESIDENTIAL, MULTIFAMILY: 2, OR 1 PER 20 UNITS

REQUIRED: 2 PROVIDED: 2 SURFACE LEVEL

i. MINIMUM GROUND LEVEL OPEN SPACE: THE MINIMUM GROUND LEVEL OPEN SPACE SHALL BE AT LEAST FIVE PERCENT OF THE TOTAL LAND AREA OF THE SITE REQUIRED: 8815 X .05 = 440.8 SF PROVIDED: 623 SF (7.1%)

BUILDING HEIGHT (FROM MEAN GRADE TO TOP OF ROOF SLAB)	73'-11"
BUILDING HEIGHT (FROM MEAN GRADE TO TOP OF ROOF SLAB)	73-11
NUMBER OF STORIES	7 STORIES + ROO
NUMBER OF UNITS	33 UNITS
BUILDING SQUARE FOOTAGE (TOTAL GROSS CONDITIONED)	35,445 SQFT
SITE SQUARE FOOTAGE	8,815 SQFT
F.A.R.	4.02
BUILDING COVERAGE (FIRST FLOOR)	6642 SF, 75.3%
PERVIOUS AREA (OPEN GREEN SPACE)	623 SF, 7.1%
IMPERVIOUS AREA	8192 SF, 92.9%
PAVING AREA (OUTSIDE BUILDING FOOTPRINT)	1551 SF, 17.6%
INTERIOR GREEN SPACE (PARKING LOT)	0 SF

APPLICABLE CODES SUMMARY

FLORIDA BUILDING CODES:
BUILDING - SEVENTH EDITION (2020)
MECHANICAL - SEVENTH EDITION (2020)
PLUMBING - SEVENTH EDITION (2020)
FUEL/GAS - SEVENTH EDITION (2020)

ENERGY - SEVENTH EDITION (2020)

ELECTRICAL CODES:
NFPA 70 NATIONAL ELECTRICAL CODE (2017 EDITION)

CCESSIBILITY CODES:

FLORIDA BUILDING CODE - ACCESSIBILITY - SEVENTH EDITION (2020) THE FAIR HOUSING ACT - US DEPARTMENT OF HOUSING AND URBAN DEVELOPMENT

ELEVATORS: ASME A17.1

AMERICAN STANDARD SAFETY CODE FOR ELEVATORS AND ESCALATORS

CITY OF ST. PETERSBURG LAND DEVELOPMENT REGULATIONS

FLORIDA FIRE PREVENTION CODE - SEVENTH EDITION (2020) W/ LOCAL AMENDMENTS: NFPA 1 - FIRE CODE

NFPA 10 - STANDARD FOR PORTABLE FIRE EXTINGUISHERS NFPA 13 - STANDARD FOR INSTALLATION OF SPRINKLER SYSTEMS

NFPA 14 - STANDARD FOR THE INSTALLATION OF STANDPIPE AND HOSE SYSTEMS
NFPA 20 - STANDARD FOR THE INSTALLATION OF STATIONARY FIRE PUMPS FOR FIRE PROTECTION
NFPA 24 - INSTALLATION OF PRIVATE FIRE SERVICE MAINS & APPURTENANCES

NFPA 54 - NATIONAL FUEL GAS CODE NFPA 72 - NATIONAL FIRE ALARM CODE

NFPA 75 - STANDARD FOR THE PROJECTION OF INFORMATION TECHNOLOGY EQUIPMENT

NFPA 88A - STANDARD FOR PARKING GARAGE STRUCTURES, 2015 EDITION
NFPA 90A - STANDARD FOR THE INSTALLATION OF AIR-CONDITION AND VENTILATING SYSTEMS
NFPA 91 - STANDARD FOR EXHAUST SYSTEMS FOR AIR CONVEYING OF VAPORS, GASES, MISTS, AND

NFPA 92 - STANDARD FOR SMOKE CONTROL SYSTEMS
NFPA 110 - STANDARD FOR EMERGENCY AND STANDBY POWER SYSTEMS
FL 44 RULES, FLORIDA STATUTES 633

NONCOMBUST. PARTICULATE SOLIDS

PROJECT TEAM DIRECTORY

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	760 4TH AVE S, ST.PETERSBURG, FL PHONE: 727 898 2270 CONTACT: M.R. ELKHOULY
M.E.P. ENGINEER	GRINER ENGINEERING, INC.
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_	146 SECOND STREET NORTH, SUITE 302, ST. PETERSBURG, FL 33701 PHONE: 727.821.5699 CONTACT: HUNTER BOOTH
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Behard Peterane ARCHITECTURE | INTERIORS (727) 800-5300 | ARCHITECTURE | S3712 (727) 800-5300 | ARCHITECTURE | PETERSBURG, FL. 33712 (727) 800-5300 | ARCHITECTURE | COUT | A 26001704 | B 26001704

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ROHIBITED.

KENNETH COWART AR93215 FLORIDA

0 4TH AVE S APARTMENTS

COVER SHEET

SHEET NUMBER:

G-00

PLUMBING FIXTURE COUNTS FBC(P), TABLE 403.1										
	OCC.		WATER CLOSET LAVATORIES		ORIES	WATER	SERVICE			
LEVEL(S)	OCCUPANCY	LOAD	MALE	FEMALE	MALE	FEMALE	MALE	FEMALE	FOUNTAINS	SINKS
	B BUSINESS	7	7 7		1 PER 50 FOR	1 PER 25 FOR THE FIRST 50; 1 PER 40 FOR THE FIRST 80; 1 PER 50 FOR THE REMAINDER EXCEEDING 50 = 0.28 EXCEEDING 80 = 0.18		DRINKING FOUNTAINS SHALL NOT BE REQUIRED FOR AN OCCUPANT LOAD OF 15 OR FEWER PER FBC(P) 410.2	SERVICE SINKS SHALL NOT BE REQUIRED FOR AN OCCUPANT LOAD OF 15 OR FEWER PER FBC(P) 403.1 EXCEPTION E	
	S-1 STORAGE	12	2 12		1 PER	100 = 0.12	1 PER 100 = 0.12		DRINKING FOUNTAINS SHALL NOT BE REQUIRED FOR AN OCCUPANT LOAD OF 15 OR FEWER PER FBC(P) 410.2	1 REQUIRED (PROVIDED AT LEVEL 7)
1	S-2 PARKING	29			GARAGE WITH NO ATTENDANTS - RESTROOMS, WATER FOUNTAINS, AND SERVICE SINKS ARE NOT REQUIRED PER FBC(P) 403.3, EXCEPTION 1					
	TOTAL REQUIRED				C	.40	0.3	60	0	1
	TOTAL PROVIDED				1 U	NISEX	1 UNISEX		0	1
2-6	R-2 RESIDENTIAL				RESIDENTIAL OCCUPANCY - RESTROOMS ARE PROVIDED IN UNITS (1 MIN. PER DWELLING UNIT)				1 KITCHEN SINK PER DWELLING UNIT; 1 AUTOMATIC CLOTHES WASHER CONNECTION PER DWELLING UNIT	
	S-1 / S2 (STORAGE)				ADDED TO LEVEL 1 COUNTS					
	A-3 (ASSEMBLY) RECREATION	58	29	29		QUIRED - FOR PUBLIC USE	NOT REQU SPACE IS NOT FO		NOT REQUIREI SPACE IS NOT FOR PL	
7	S1/S-2 (STORAGE)				ADDED TO LEVEL 1 COUNTS					
	R-2 RESIDENTIAL				RESIDENTIAL OCCUPANCY - RESTROOMS ARE PROVIDED IN UNITS (1 MIN. PER DWELLING UNIT)					1 KITCHEN SINK PER DWELLING UNIT; 1 AUTOMATIC CLOTHES WASHER CONNECTION PER DWELLING UNIT
	TOTAL REQUIRED					0	0		0	0
	TOTAL PROVIDED				1 UNISEX (C	ONVENIENCE)	1 UNISEX (CO	NVENIENCE)	2 (1 HI-LO CONVENIENCE)	1 REQUIRED (PROVIDED AT LEVEL 7)

OCCUPANCY TYPE FBC 303.4	R-2 APARTAMENT BUILDING
HIGHEST OCCUPIED FLOOR - LEVEL 7	= +/- 61'-11" ABOVE MEAN GRADE
RISK CATEGORY II FBC TABLE 1604.5	(LESS THAN 5,000 OCCUPANTS)
TYPE OF CONSTRUCTION FBC CH. 6	TYPE IB (SPRINKLERED)
BUILDING HEIGHT & AREAS: FBC TABLE 504.3, 504.4, 506.2, 510	ALLOWED: 180', 12 STORIES, UNLIMITED S.F. PER FLOOR PROPOSED: +/- 73' - 11" HEIGHT, 7 STORIES, 6,11 S.F. PER FLOOR MAX.
FIRE RESISTANCE RATING REQUIREMENTS: FBC TABLE 601	
PRIMARY STRUCTURAL FRAME BEARING WALL - EXT BEARING WALL - INT NON-BEARING WALLS & PARTITIONS FLOOR CONSTRUCTION ROOF CONSTRUCTION	2 HOUR 2 HOUR 2 HOUR 0 HOURS 2 HOUR 1 HOUR
FIRE RESISTANCE RATING REQUIREMENTS: FBC TABLE 602	
FIRE SEPARATION DISTANCE X<5': FIRE SEPARATION DISTANCE 5'≤X<10': FIRE SEPARATION DISTANCE 10'≤X<30': FIRE SEPARATION DISTANCE X≥ 30':	1 HOUR 1 HOUR 1 HOUR 0 HOUR
EXTERIOR WALL OPENING LIMITATIONS: (SPRINKLERED, UNPROTECTED) - FBC TABLE 705.8	
FIRE SEPARATION DISTANCE X<3': FIRE SEPARATION DISTANCE 3'≤X<5': FIRE SEPARATION DISTANCE 5'≤X<10': FIRE SEPARATION DISTANCE 10'≤X<15': FIRE SEPARATION DISTANCE 15'≤X<20': FIRE SEPARATION DISTANCE X≥20':	NOT PERMITTED 15% 25% 45% 75% NO LIMIT
FBC 713.4, NFPA101 30.3.1.1.4	
ELEVATOR HOISTWAYS: VERTICAL SHAFTS: STAIRWAYS:	2 HOUR, 90 MIN. DOOR 2 HOUR 2 HOUR, 90 MIN. DOOR
FBC 903.2.1, 903.2.8, NFPA 101 9.7 & NFPA 13	AUTOMATIC SPRINKLER SYSTEM SHALL BE PROVIDED AND COMPLIANT WITH NFPA 13
FBC 905.1 905.2 & NFPA 14 AT EACH FLOOR	STANDPIPE SYSTEM SHALL BE PROVIDED
FBC 905.4 #5 & NFPA 14 AT EACH FLOOR	STANDPIPE SYSTEM SHALL EXTEND TO ROOF
NFPA 1 13.6	PORTABLE FIRE EXTINGUISHERS REQUIRED: CABINET / BRACKET TYPE PROVIDED AT 75 FT. TRAVEL DISTANCE
REFER TO CODE PLAN FOR MEANS OF EGRESS, COMMON F STAIRWAY WIDTH, EXIT DOOR WIDTH	PATH OF TRAVEL, DEAD END CORRIDORS, EGRESS

COMPONENTS & CLADDING SCHEDULE

CORRIDORS

ROOM/ ENCLOSED SPACES

ALL INTERIOR FINISHES SHALL COMPLY WITH FBC TABLE 803.11 (SPRINKLERED)

EXIT ENCLOSURE

S-1,S-2

COMPONENT	3 & CLADDING 3CI	ILDULL
BUILDING COMPONENT	MANUFACTURER / MODEL	NOA/FPA #:
STOREFRONT SYSTEM	YKK YHS 50 FI	FL 14218.3
OUTSWING STOREFRONT DOOR SYSTEM	YKK AP AMERICA - 35 OUTSWING	FL 16544.1
SLIDING DOORS	PGT SGD-5570	FL 251.9
SLIDING WINDOWS WITH BOTTOM FIXED TRANSOM	PGT 5510 (WITH MULLED FIXED TRANSOM)	FL 242.2
DECORATIVE EIFS CLADDING / SIDING SYSTEM	DRYVIT - OUTSULATION PLUS	FL 20075.1
EXTERIOR SOFFIT SUSPENSION SYSTEM	WORTHINGTON ARMSTRONG VENTURES (WAVE) WITH THERMORY - ASH CLADDING	NOA 22-0309.04
TRAFFIC COATING SYSTEM	TREMCO VULKEM 350 WATERPROOFING SYSTEM	NOA 20-0313.01
EXTERIOR HOLLOW METAL DOOR	CECO DOOR (IN/OUT-SWING SYSTEM)	FL 4553
TPO ROOFING SYSTEM	JOHNS MANVILLE TPO MEMBRANE ROOFING SYSTEM, 60 MIL FLEECEBACK	FL 16758.2

PROPOSED FLORIDA PRODUCT APPROVED SYSTEMS MEET OR EXCEED THE CITY OF ST PETERSBURG MINIMUM WIND DESIGN REQUIREMENTS. REFER TO STRUCTURAL DOCUMENTS FOR APPLICABLE MINIMUM COMPONENT AND CLADDING WIND PRESSURES SPECIFIC TO PROJECT LOCATION.

DESIGN FEATURES REQUIRING PROJECT SPECIFIC ENGINEERING

MANUFACTURERS OF COMPONENTS LISTED BELOW SHALL PROVIDE ENGINEERING DOCUMENTATION CONFIRMING COMPLIANCE WITH APPLICABLE BUILDING CODES AND LOCAL WIND LOAD REQUIREMENTS

THROUGH SHOP DRAWING SUBMITTALS TO THE ARCHITECT AND STRUCTURAL ENGINEER.				
BUILDING COMPONENT	MANUFACTURER / MODEL			
BUILDING SIGNAGE	TO BE DETERMINED BY OWNER, DEFERRED SUBMITTAL			
STOREFRONT SYSTEM	YKK, WEST TAMPA GLASS, OR APPROVED EQUAL - DEFERRED STRUCTURAL CALCULATIONS / DESIGN SUBMITTAL			
EXTERIOR LIGHT GAUGE METAL STUD WORK	DEFERRED STRUCTURAL CALCULATIONS / DESIGN SUBMITTAL			
ALUMINUM GUARDRAIL AND HANDRAILS	DEFERRED STRUCTURAL CALCULATIONS / DESIGN SUBMITTAL			
MILLWORK	MILLWORK SUBCONTRACTOR TO ASSEMBLE SHOP DRAWINGS COORDINATED WITH OWNER. CONTRACTOR TO SUBMIT SHOP DRAWINGS TO DESIGN TEAM FOR APPROVAL.			

TERMITE TREATMENT

TREAT PROJECT AREA AGAINST INFESTATION BY SUBTERRANEAN TERMITES PER CHAPTER 18, SECTION 1816.1 OF THE FLORIDA BUILDING CODE - SEVENTH EDITION (2020).



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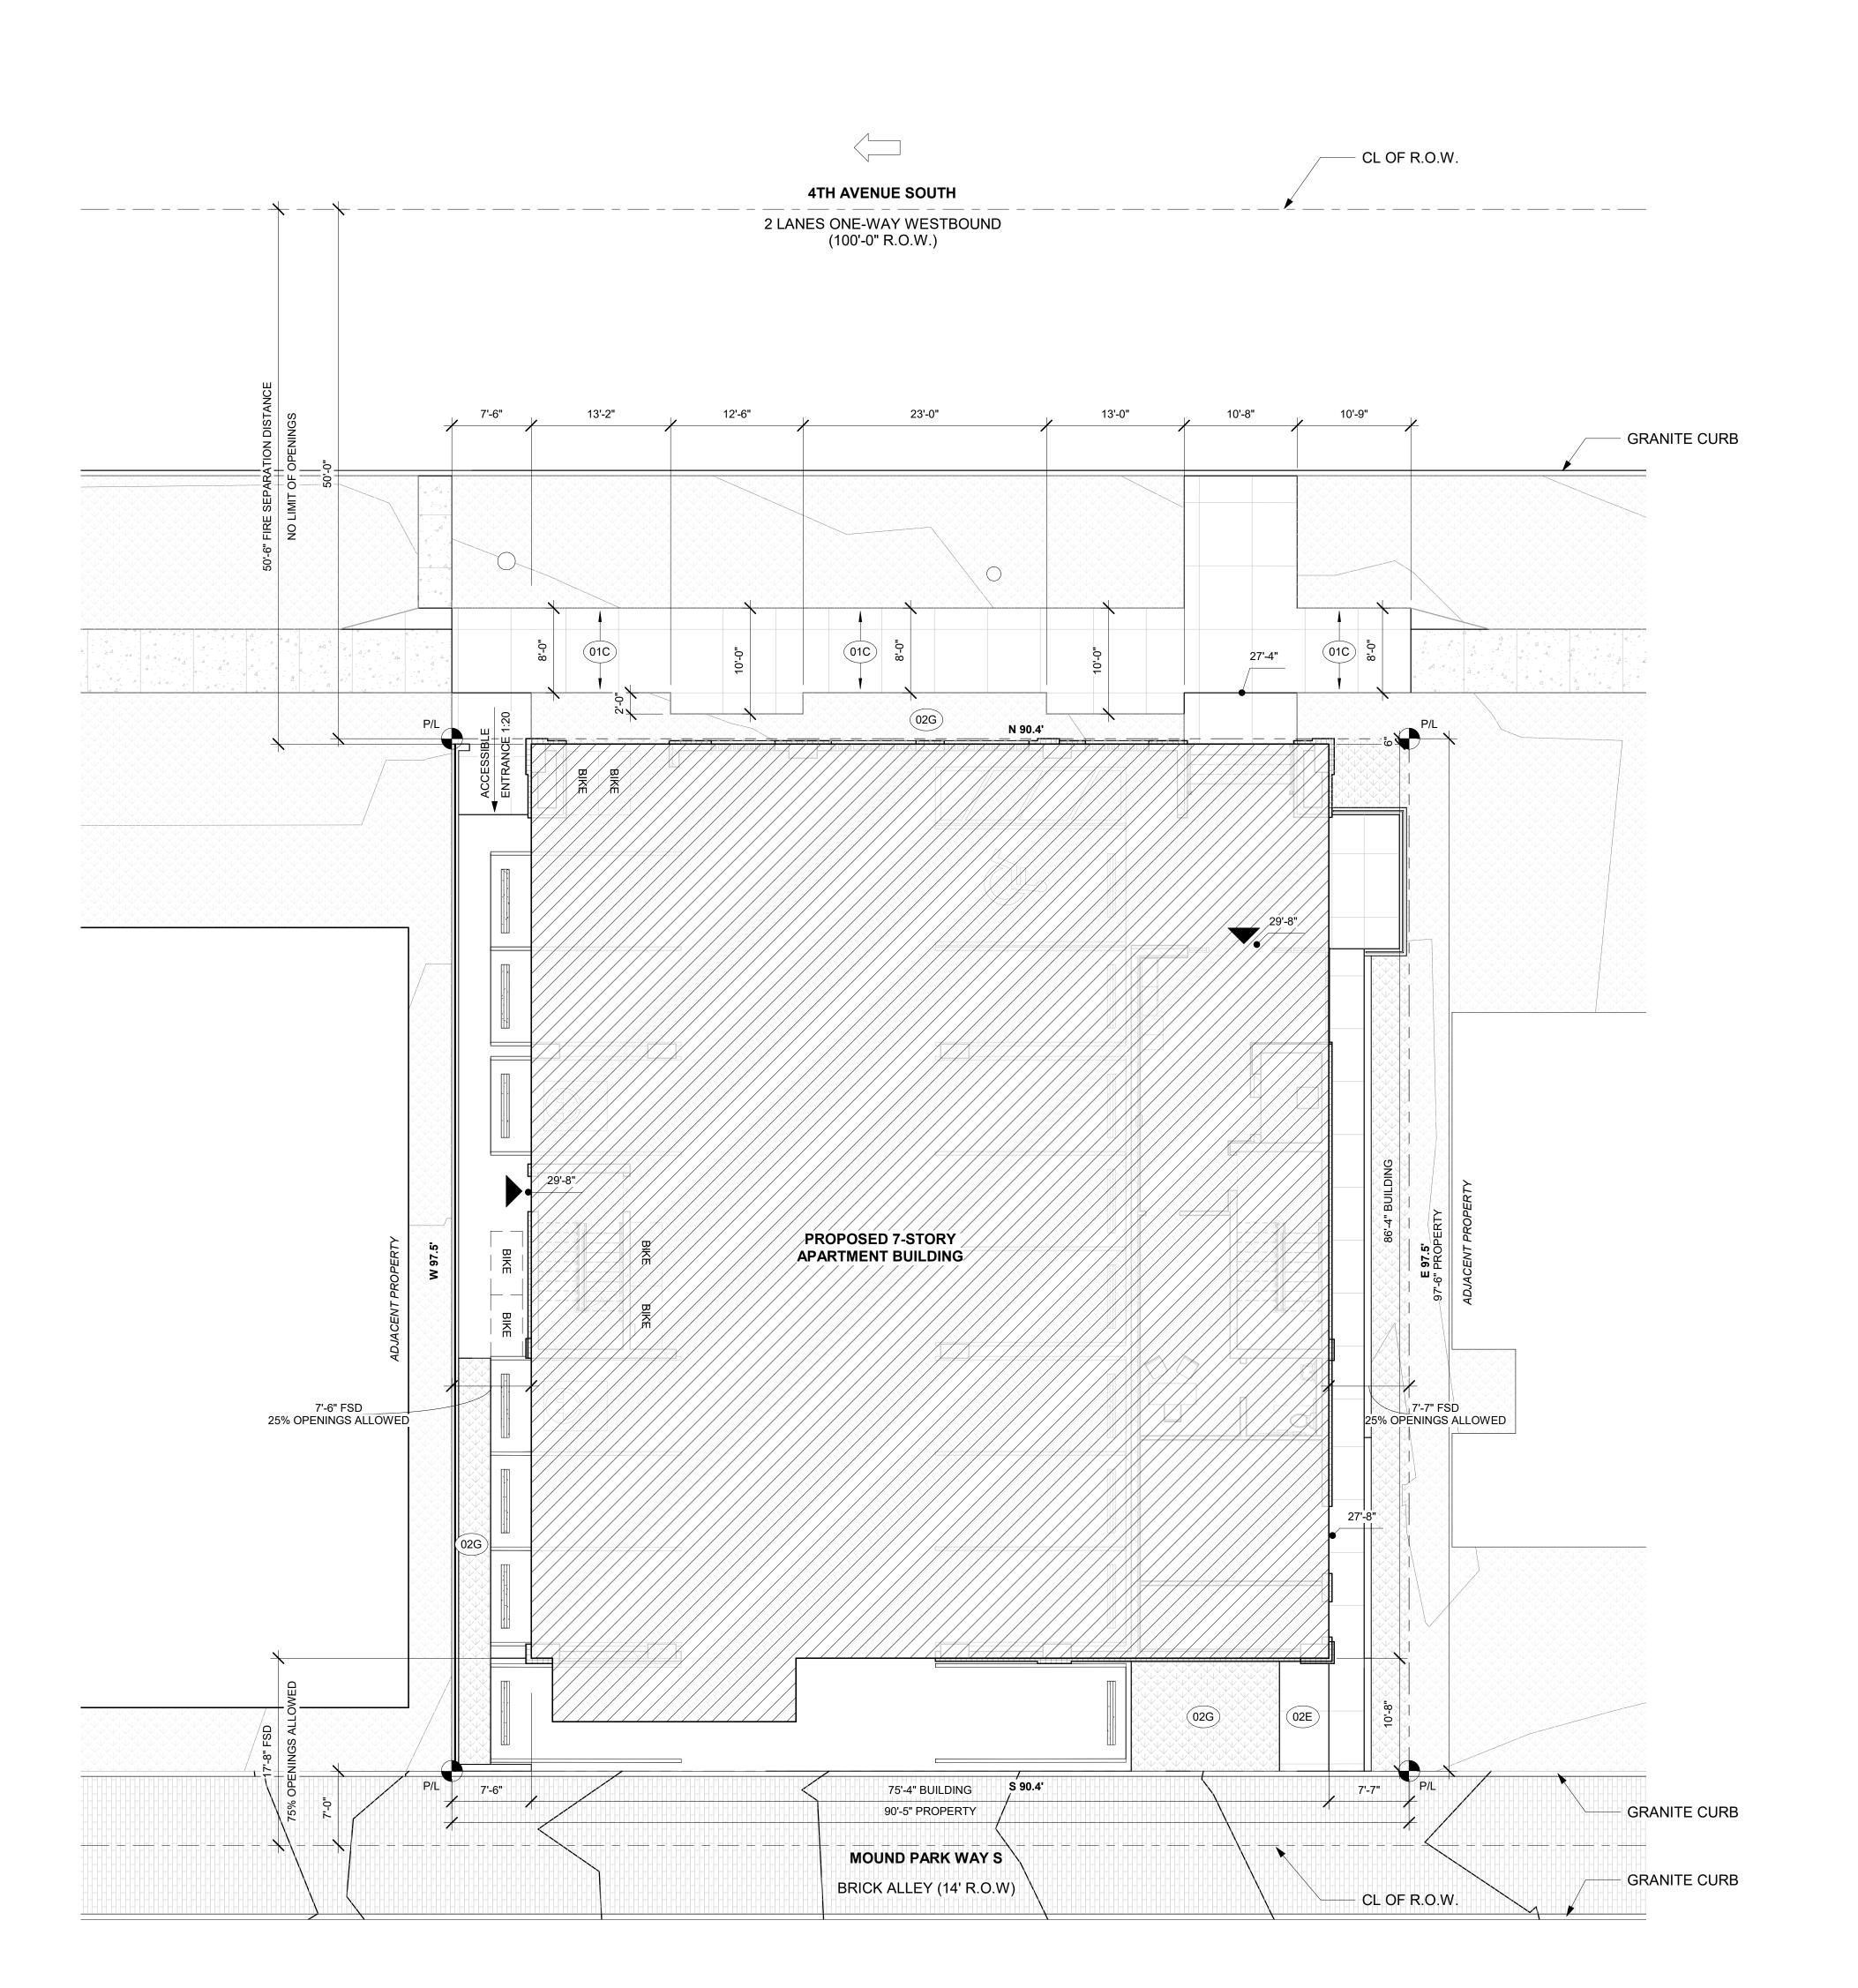
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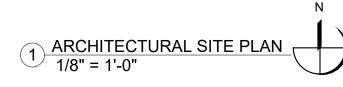
ISSUED DRAWING LOG: # DATE DESCRIPTION

PROJECT NUMBER: 22.030

ISSUE DATE: 03.01.2023 DRAWING TITLE: PROJECT DATA AND CODES

SHEET NUMBER: G-003








. HVAC EQUIPMENT TO BE ROOF MOUNTED. REFER TO A-108 FOR ADDITIONAL INFORMATION. REFER TO CIVIL DOCUMENTS FOR LEGAL DESCRIPTION OF SITE AND ADDITIONAL SITE INFORMATION





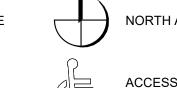




FLOOD ZONE DATA

PROPOSED FINISHED FLOOR ELEVATION: 29.66' FEMA FLOOD MAP ZONE: NON EVAC

POINT

FLOOD CERTIFICATE NOT REQUIRED OUTSIDE OF ZONE AE (FEMA FLOOD ZONE AE: 8.0' AND BELOW - 100 YEAR FLOOR PLAIN)

MATERIAL LEGEND

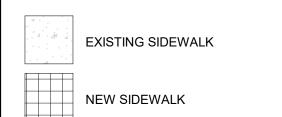

PARKING

VEHICLE PARKING: DWELLING, MULTIFAMILY: MORE THAN 750 SQUARE FEET: 1 PER UNIT; EQUAL TO OR LESS THAN 750 SQUARE FEET: ZERO (0) PER UNIT. LOADING AREA REQUIRED FOR MORE THAN 5 UNITS REQUIRED: 33 TOTAL UNITS - 20 UNDER 750 SF = 13 SPACES 1 ADA SPACE REQUIRED PER FBC ACCESIBILITY **TABLE 208.2**

PROVIDED: 16 (INCLUDING 1 ADA SPACE) LONG TERM BICYCLE PARKING: RESIDENTIAL, MULTIFAMILY: 1 PER EACH UNIT REQUIRED: 33 SPACES

PROVIDED: 33 (1 PER UNIT) + 5 SURFACE LEVEL = 38
SHORT TERM BICYCLE PARKING: RESIDENTIAL, MULTIFAMILY: 2, OR 1 PER 20 UNITS REQUIRED: 2 PROVIDED: 2

KEYNOTE LEGEND

LANDSCAPE ARCHITECTURE AND CIVIL SCOPE SHOWN FOR REFERENCE ONLY. REFER TO LANDSCAPE ARCHITECTURE AND CIVIL DOCUMENTS FOR ADDITIONAL INFORMATION. TRASH PICKUP AREA: REFER TO CIVIL DOCUMENTS

FOR ADDITIONAL INFORMATION. LANDSCAPING AREA: REFER TO CIVIL AND LANDSCAPE DOCUMENTS FOR ANY PROPOSED POLE LOCATIONS, PLANTING LOCATIONS, PARKING SIGNAGE, AND SHORT TERM BIKE RACK LOCATIONS AND DETAILS.

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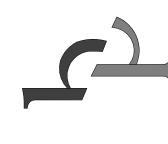
> KENNETH COWART AR93215 FLORIDA

ISSUED DRAWING LOG: # DATE DESCRIPTION

PROJECT NUMBER: ISSUE DATE: 03.01.2023

DRAWING TITLE:
ARCHITECTURAL SITE
PLAN





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ISSUED DRAWING LOG:

PROJECT NUMBER:

22.030

ISSUE DATE:

03.01.2023


DRAWING TITLE:
BUILDING ISOMETRIC
VIEWS


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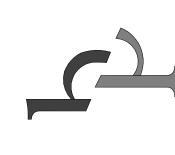
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2 SOUTHWEST ISOMETRIC



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ISSUED DRAWING LOG:

PROJECT NUMBER:

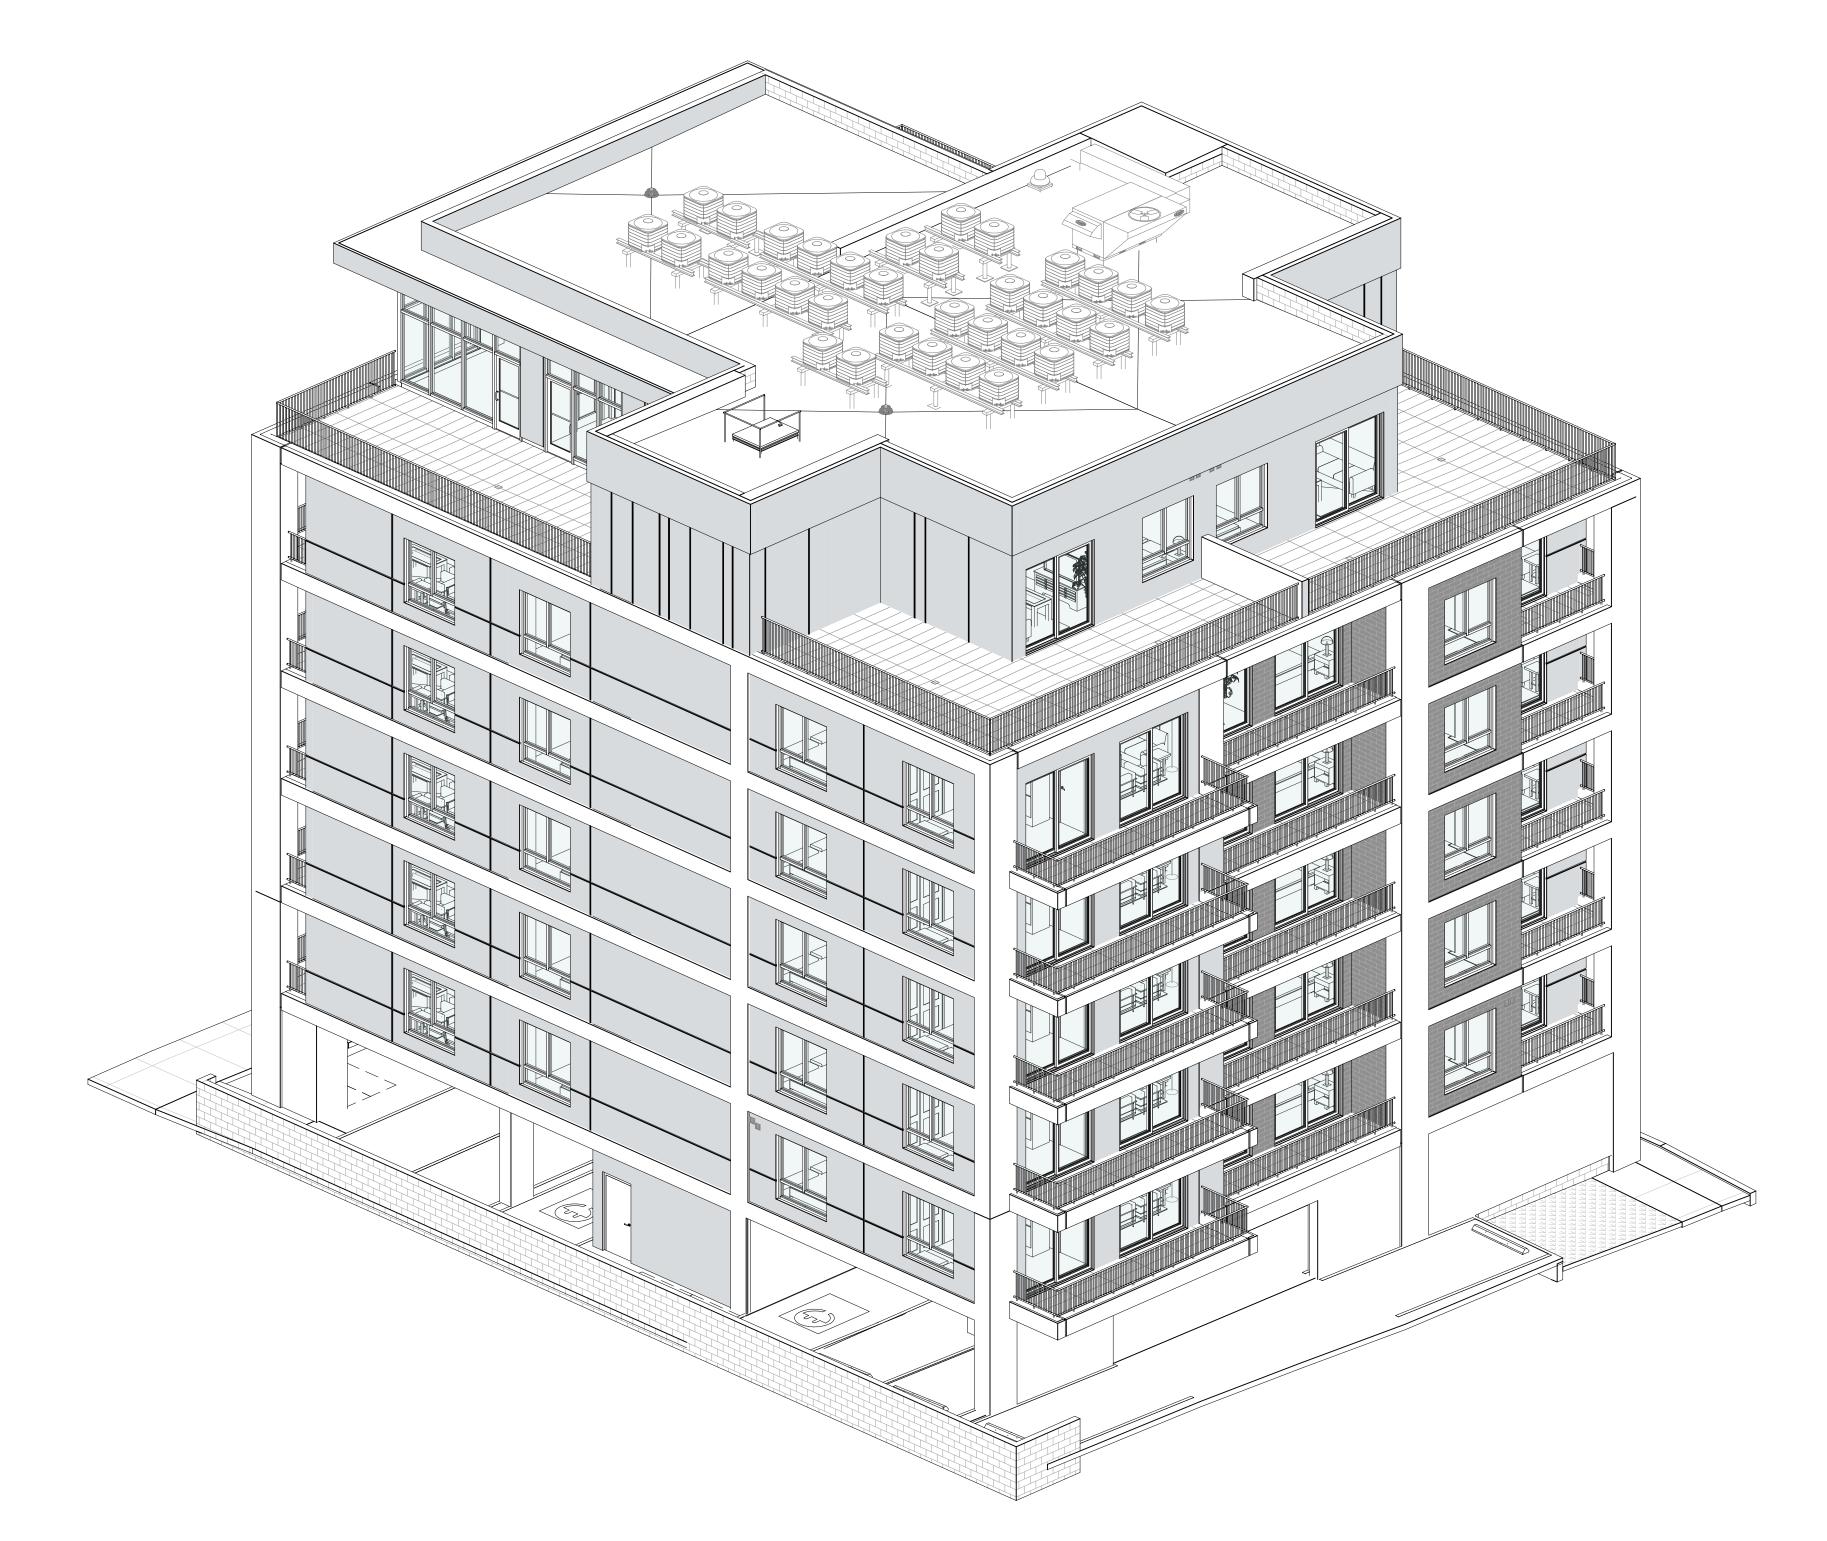22.030

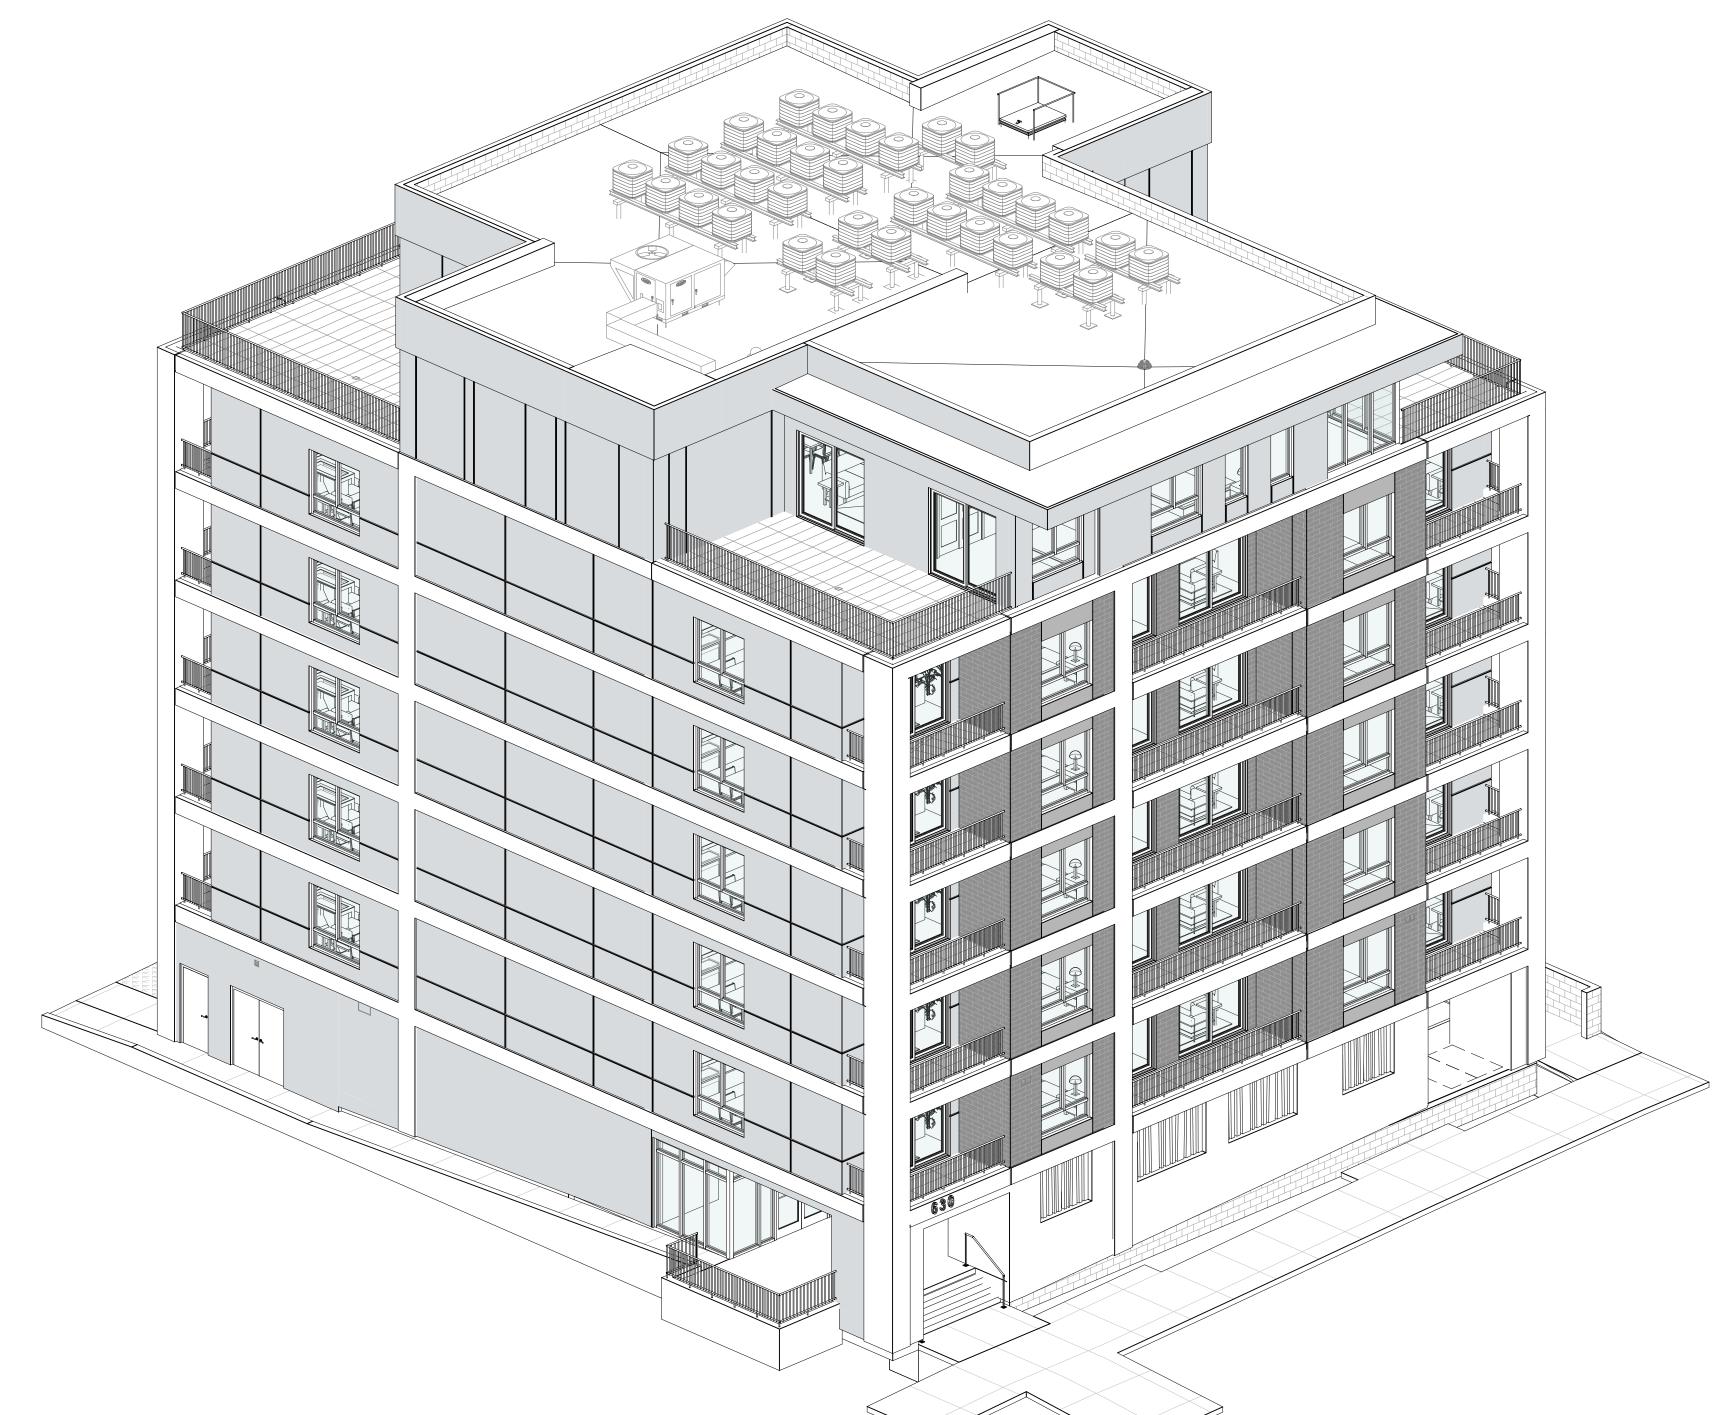ISSUE DATE:

03.01.2023


DRAWING TITLE:
BUILDING ISOMETRIC VIEWS


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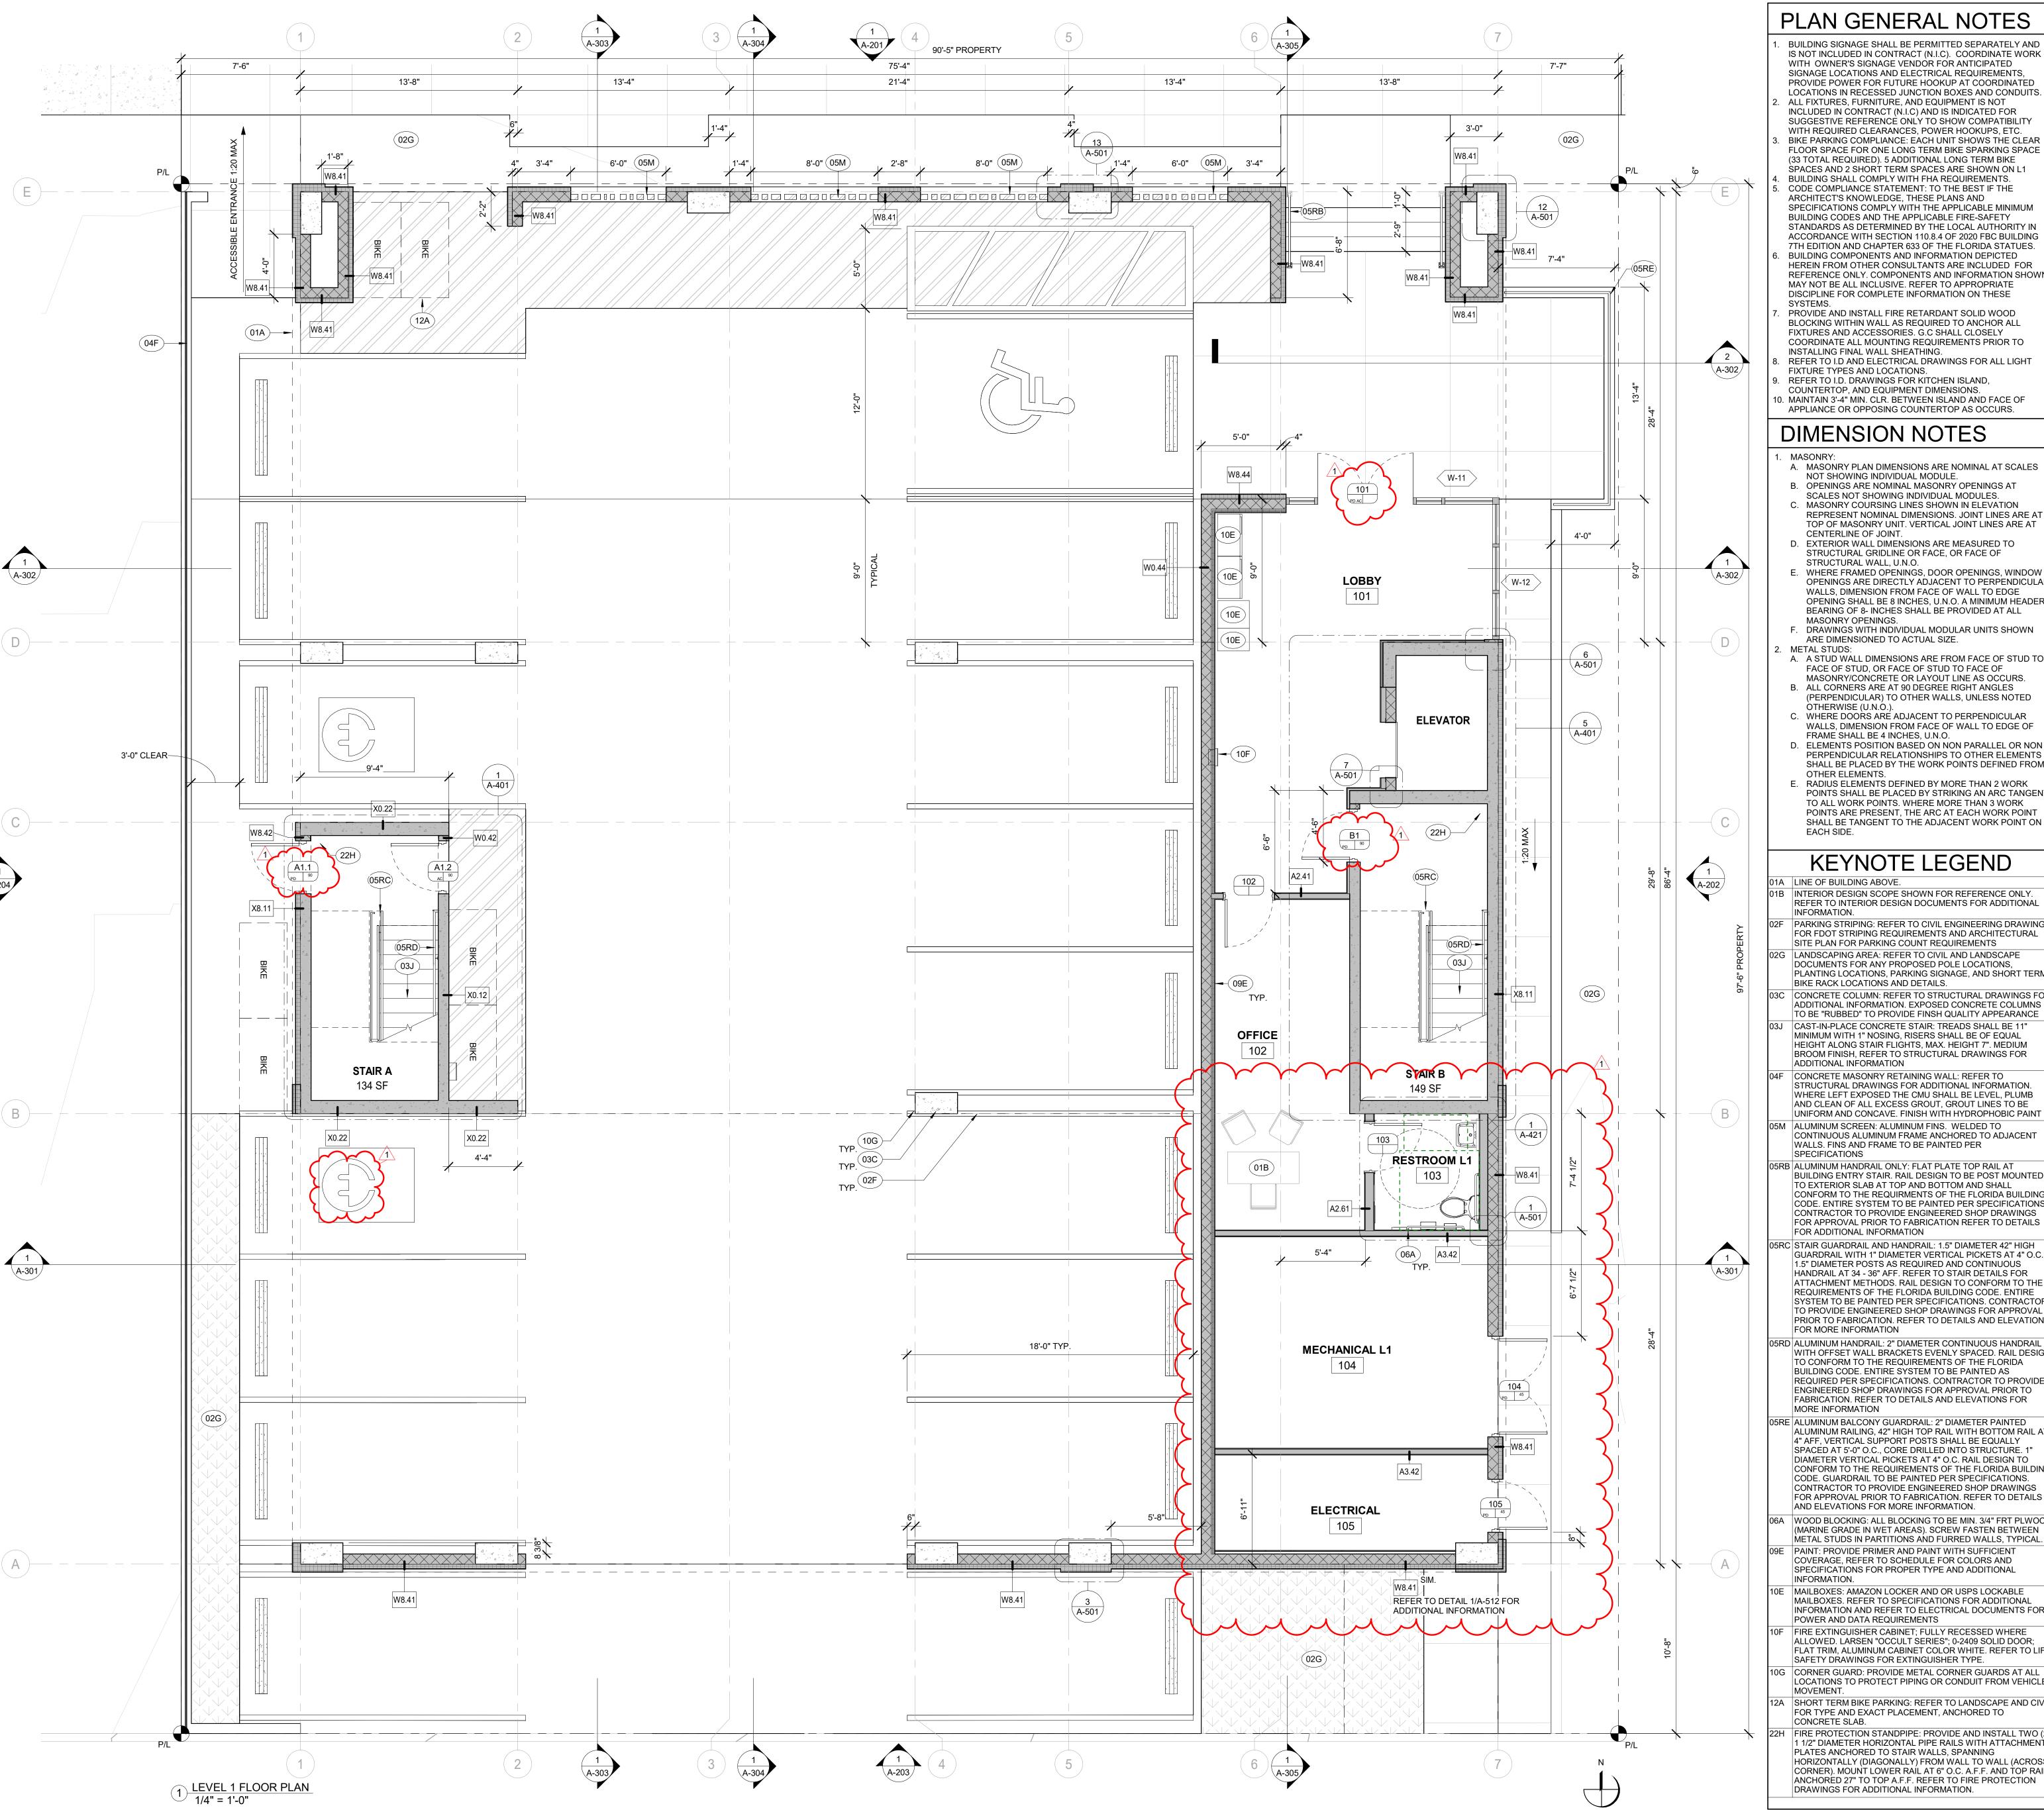
A-012

EDITION:

PERMIT SET



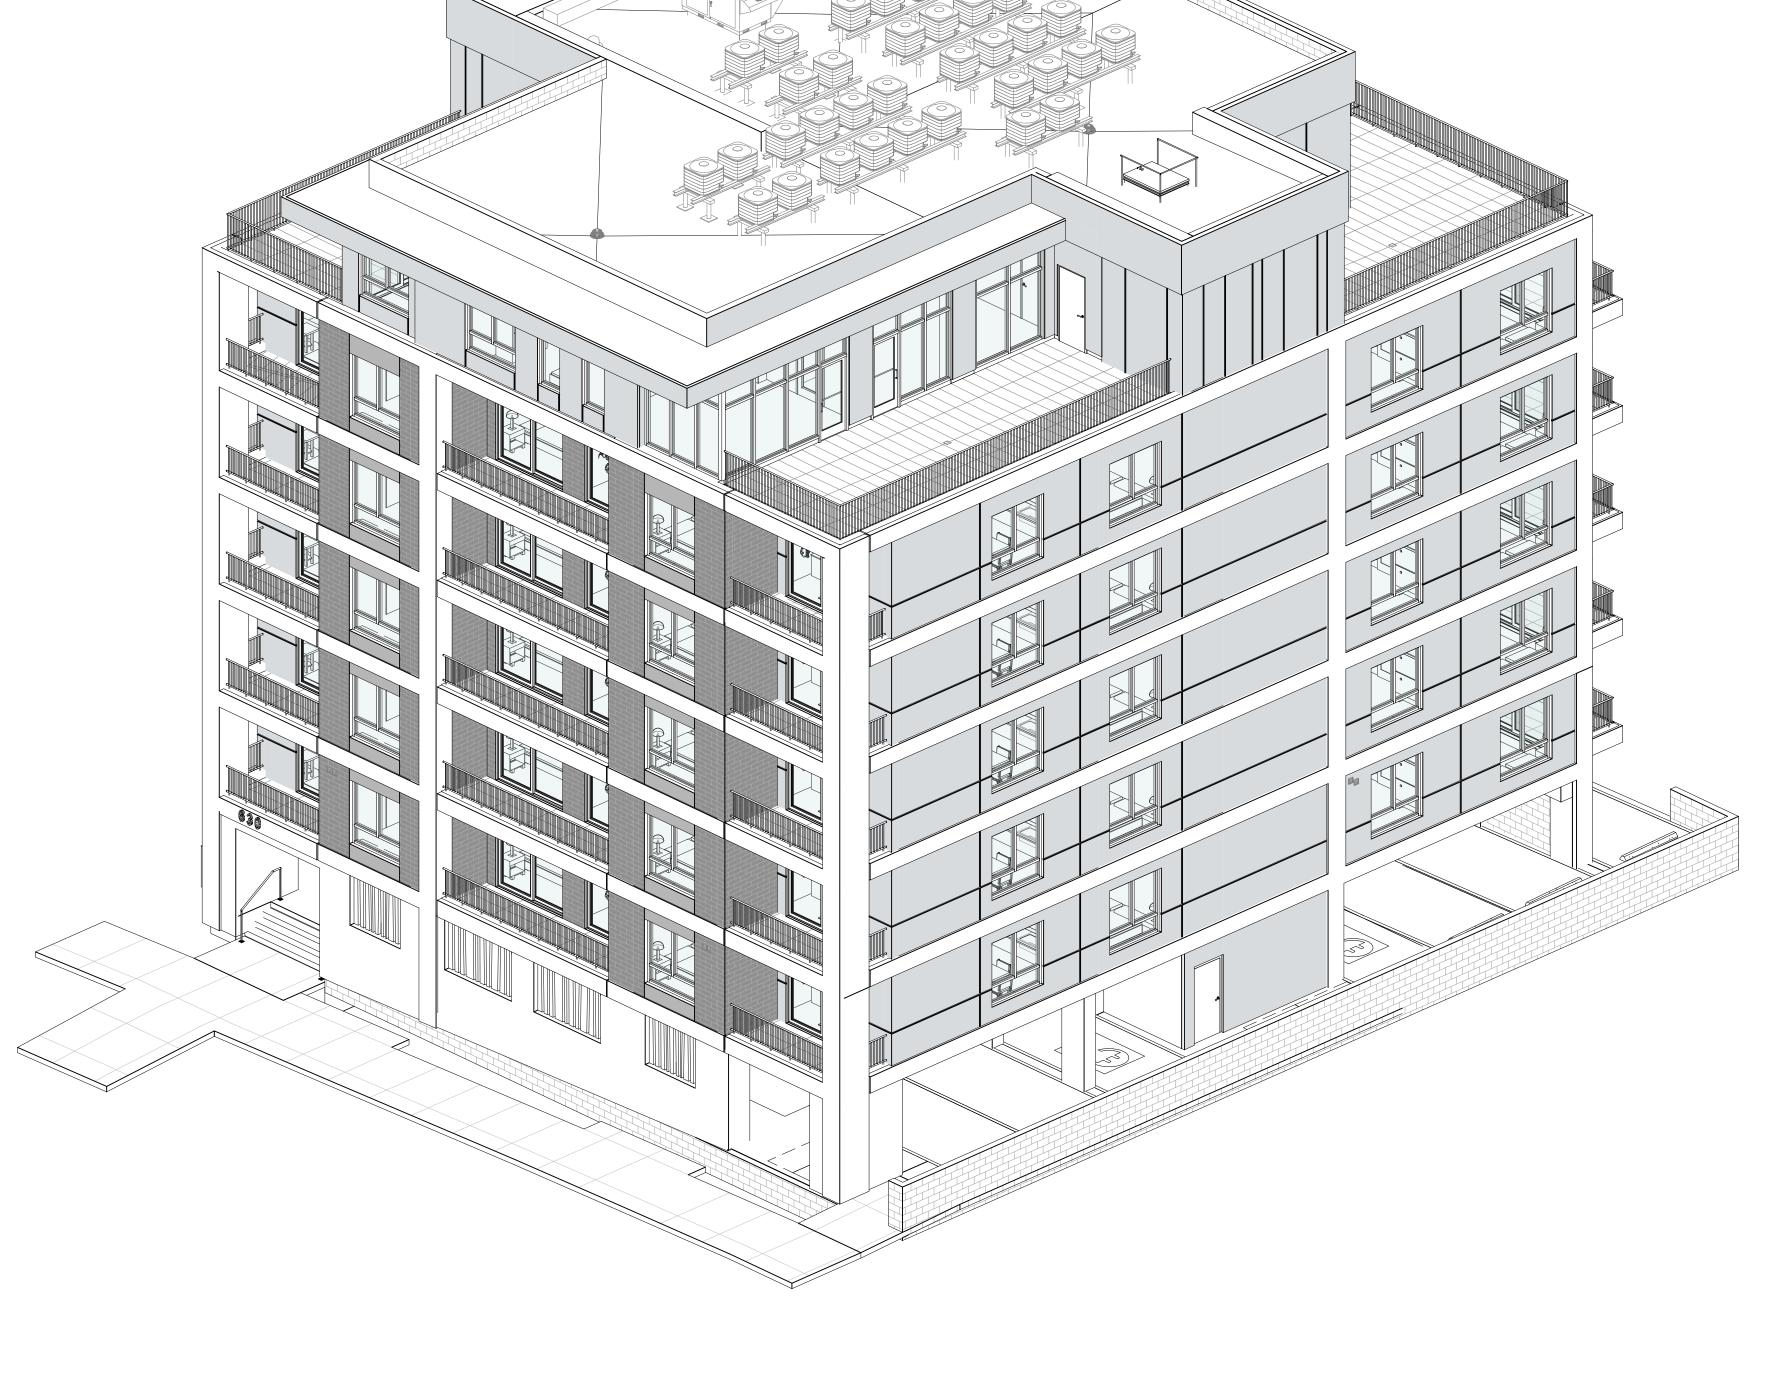

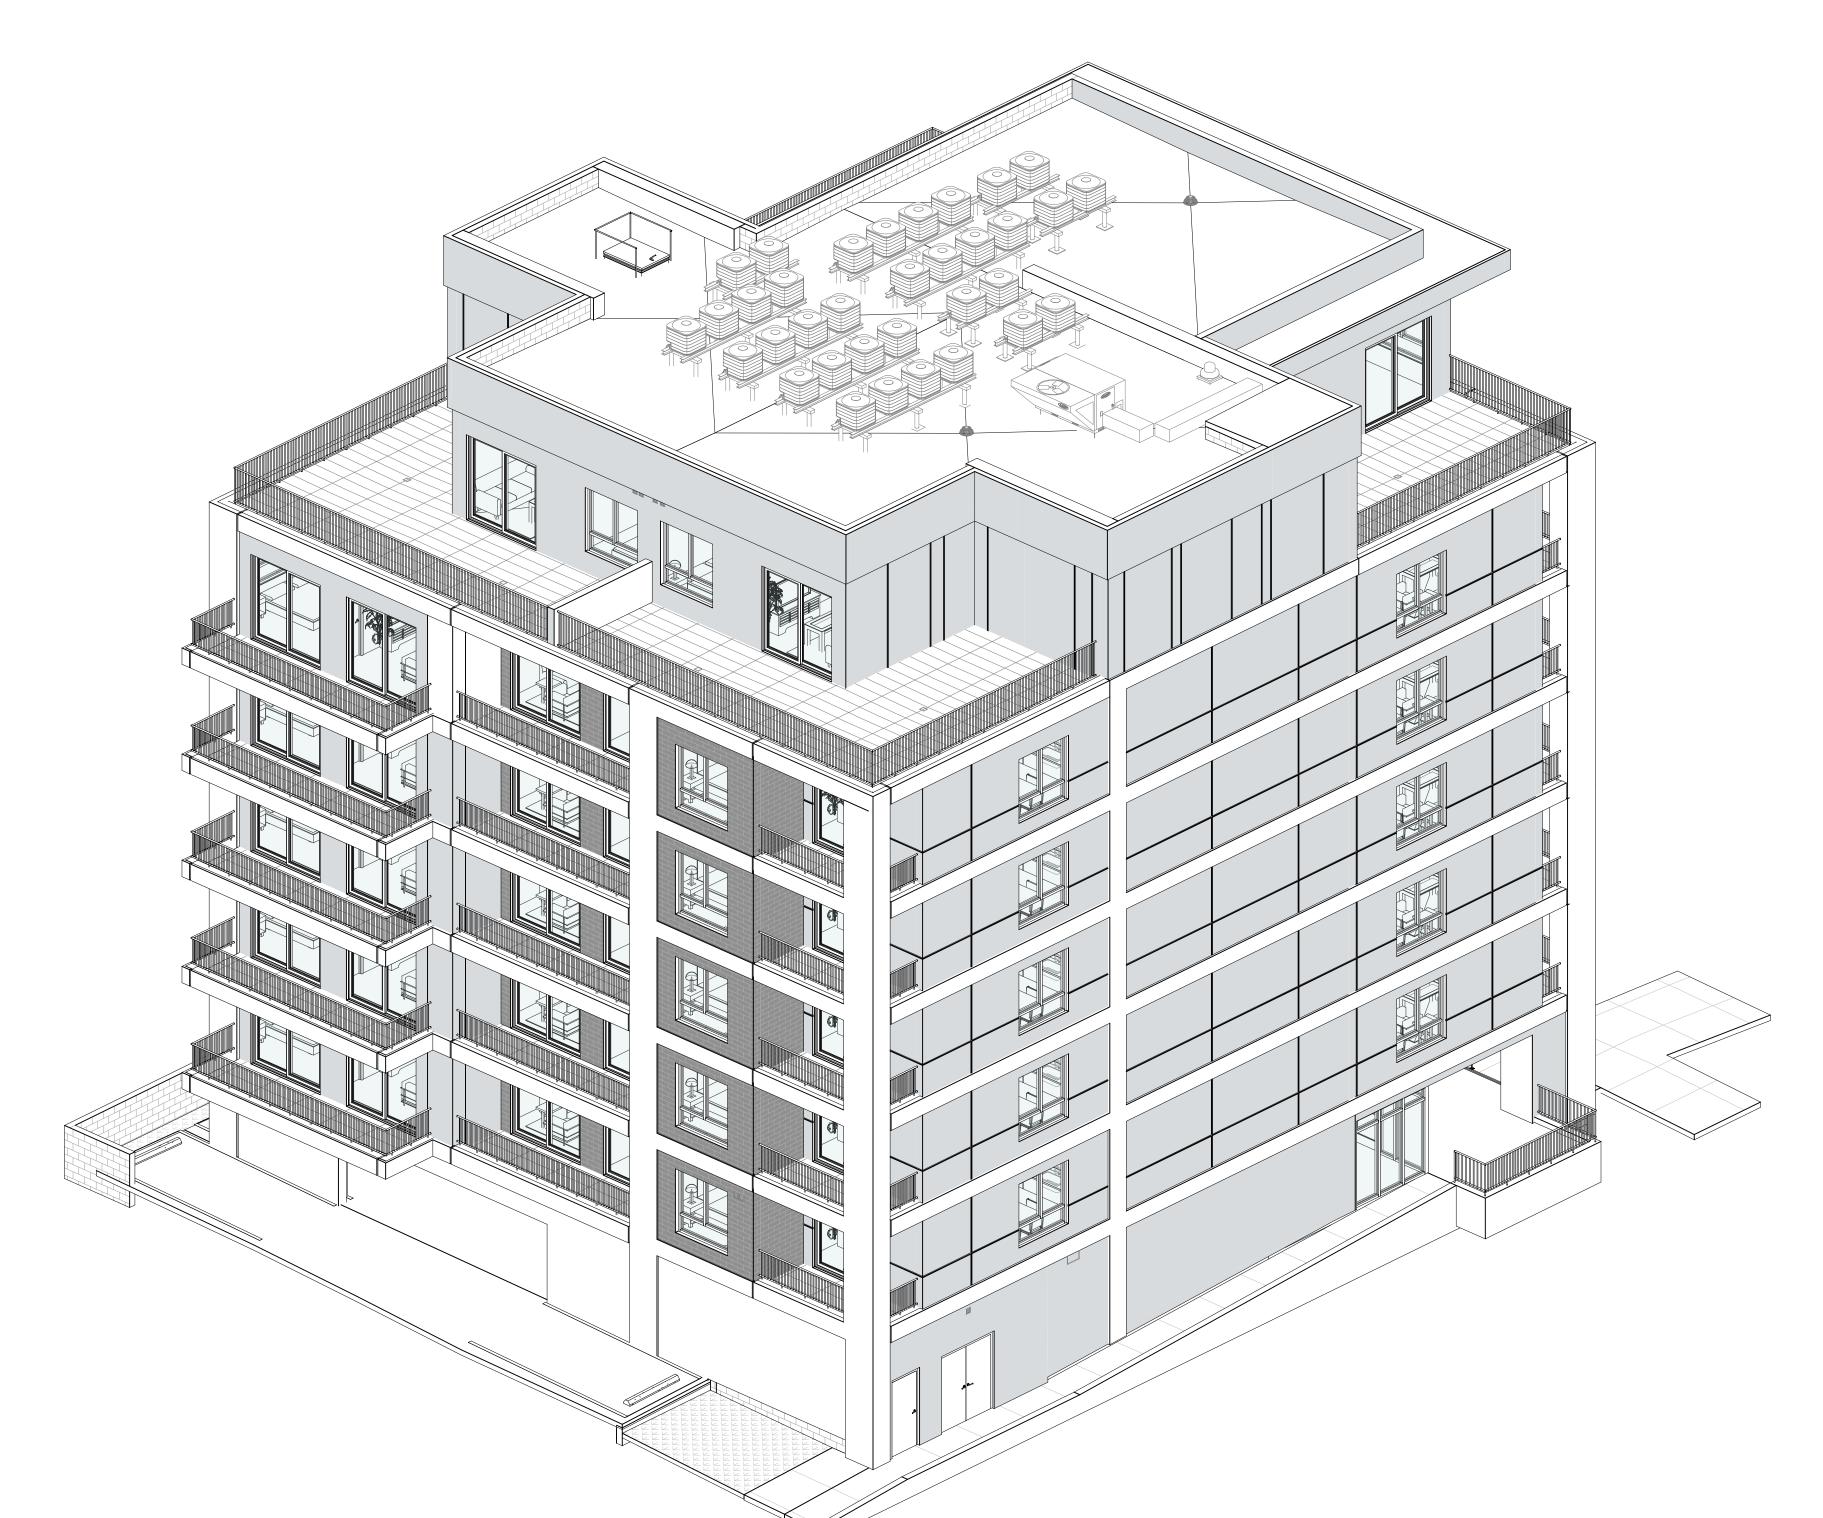

PLAN GENERAL NOTES

BUILDING SIGNAGE SHALL BE PERMITTED SEPARATELY AND IS NOT INCLUDED IN CONTRACT (N.I.C). COORDINATE WORK WITH OWNER'S SIGNAGE VENDOR FOR ANTICIPATED SIGNAGE LOCATIONS AND ELECTRICAL REQUIREMENTS, PROVIDE POWER FOR FUTURE HOOKUP AT COORDINATED LOCATIONS IN RECESSED JUNCTION BOXES AND CONDUITS. ALL FIXTURES, FURNITURE, AND EQUIPMENT IS NOT INCLUDED IN CONTRACT (N.I.C) AND IS INDICATED FOR SUGGESTIVE REFERENCE ONLY TO SHOW COMPATIBILITY WITH REQUIRED CLEARANCES, POWER HOOKUPS, ETC. BIKE PARKING COMPLIANCE: EACH UNIT SHOWS THE CLEAR FLOOR SPACE FOR ONE LONG TERM BIKE SPARKING SPACE (33 TOTAL REQUIRED), 5 ADDITIONAL LONG TERM BIKE SPACES AND 2 SHORT TERM SPACES ARE SHOWN ON L1 BUILDING SHALL COMPLY WITH FHA REQUIREMENTS. CODE COMPLIANCE STATEMENT: TO THE BEST IF THE ARCHITECT'S KNOWLEDGE, THESE PLANS AND

SPECIFICATIONS COMPLY WITH THE APPLICABLE MINIMUM BUILDING CODES AND THE APPLICABLE FIRE-SAFETY STANDARDS AS DETERMINED BY THE LOCAL AUTHORITY IN ACCORDANCE WITH SECTION 110.8.4 OF 2020 FBC BUILDING 7TH EDITION AND CHAPTER 633 OF THE FLORIDA STATUES. BUILDING COMPONENTS AND INFORMATION DEPICTED HEREIN FROM OTHER CONSULTANTS ARE INCLUDED FOR REFERENCE ONLY. COMPONENTS AND INFORMATION SHOWN MAY NOT BE ALL INCLUSIVE. REFER TO APPROPRIATE DISCIPLINE FOR COMPLETE INFORMATION ON THESE

PROVIDE AND INSTALL FIRE RETARDANT SOLID WOOD BLOCKING WITHIN WALL AS REQUIRED TO ANCHOR ALL FIXTURES AND ACCESSORIES. G.C SHALL CLOSELY COORDINATE ALL MOUNTING REQUIREMENTS PRIOR TO INSTALLING FINAL WALL SHEATHING. REFER TO I.D AND ELECTRICAL DRAWINGS FOR ALL LIGHT FIXTURE TYPES AND LOCATIONS. REFER TO I.D. DRAWINGS FOR KITCHEN ISLAND,

DIMENSION NOTES

- NOT SHOWING INDIVIDUAL MODULE. B. OPENINGS ARE NOMINAL MASONRY OPENINGS AT SCALES NOT SHOWING INDIVIDUAL MODULES. . MASONRY COURSING LINES SHOWN IN ELEVATION REPRESENT NOMINAL DIMENSIONS. JOINT LINES ARE AT
- TOP OF MASONRY UNIT. VERTICAL JOINT LINES ARE AT CENTERLINE OF JOINT. D. EXTERIOR WALL DIMENSIONS ARE MEASURED TO STRUCTURAL GRIDLINE OR FACE, OR FACE OF STRUCTURAL WALL, U.N.O.
- . WHERE FRAMED OPENINGS, DOOR OPENINGS, WINDOW OPENINGS ARE DIRECTLY ADJACENT TO PERPENDICULAR WALLS, DIMENSION FROM FACE OF WALL TO EDGE OPENING SHALL BE 8 INCHES, U.N.O. A MINIMUM HEADER BEARING OF 8- INCHES SHALL BE PROVIDED AT ALL MASONRY OPENINGS. F. DRAWINGS WITH INDIVIDUAL MODULAR UNITS SHOWN ARE DIMENSIONED TO ACTUAL SIZE.
- A. A STUD WALL DIMENSIONS ARE FROM FACE OF STUD TO FACE OF STUD, OR FACE OF STUD TO FACE OF MASONRY/CONCRETE OR LAYOUT LINE AS OCCURS. B. ALL CORNERS ARE AT 90 DEGREE RIGHT ANGLES
- (PERPENDICULAR) TO OTHER WALLS, UNLESS NOTED OTHERWISE (U.N.O.). C. WHERE DOORS ARE ADJACENT TO PERPENDICULAR
- WALLS, DIMENSION FROM FACE OF WALL TO EDGE OF FRAME SHALL BE 4 INCHES, U.N.O. D. ELEMENTS POSITION BASED ON NON PARALLEL OR NON PERPENDICULAR RELATIONSHIPS TO OTHER ELEMENTS
- SHALL BE PLACED BY THE WORK POINTS DEFINED FROM OTHER ELEMENTS. E. RADIUS ELEMENTS DEFINED BY MORE THAN 2 WORK POINTS SHALL BE PLACED BY STRIKING AN ARC TANGENT TO ALL WORK POINTS. WHERE MORE THAN 3 WORK POINTS ARE PRESENT, THE ARC AT EACH WORK POINT SHALL BE TANGENT TO THE ADJACENT WORK POINT ON

KEYNOTE LEGEND

- 01A LINE OF BUILDING ABOVE. 01B INTERIOR DESIGN SCOPE SHOWN FOR REFERENCE ONLY.
- REFER TO INTERIOR DESIGN DOCUMENTS FOR ADDITIONAL INFORMATION. 02F PARKING STRIPING: REFER TO CIVIL ENGINEERING DRAWINGS
- FOR FDOT STRIPING REQUIREMENTS AND ARCHITECTURAL SITE PLAN FOR PARKING COUNT REQUIREMENTS 02G LANDSCAPING AREA: REFER TO CIVIL AND LANDSCAPE DOCUMENTS FOR ANY PROPOSED POLE LOCATIONS, PLANTING LOCATIONS, PARKING SIGNAGE, AND SHORT TERM
- 03C CONCRETE COLUMN: REFER TO STRUCTURAL DRAWINGS FOR ADDITIONAL INFORMATION. EXPOSED CONCRETE COLUMNS TO BE "RUBBED" TO PROVIDE FINSH QUALITY APPEARANCE CAST-IN-PLACE CONCRETE STAIR: TREADS SHALL BE 11" MINIMUM WITH 1" NOSING, RISERS SHALL BE OF EQUAL
- HEIGHT ALONG STAIR FLIGHTS, MAX. HEIGHT 7". MEDIUM BROOM FINISH, REFER TO STRUCTURAL DRAWINGS FOR ADDITIONAL INFORMATION 04F CONCRETE MASONRY RETAINING WALL: REFER TO STRUCTURAL DRAWINGS FOR ADDITIONAL INFORMATION.
- WHERE LEFT EXPOSED THE CMU SHALL BE LEVEL, PLUMB AND CLEAN OF ALL EXCESS GROUT, GROUT LINES TO BE UNIFORM AND CONCAVE. FINISH WITH HYDROPHOBIC PAINT 05M ALUMINUM SCREEN: ALUMINUM FINS. WELDED TO CONTINUOUS ALUMINUM FRAME ANCHORED TO ADJACENT
- WALLS. FINS AND FRAME TO BE PAINTED PER SPECIFICATIONS 05RB ALUMINUM HANDRAIL ONLY: FLAT PLATE TOP RAIL AT BUILDING ENTRY STAIR. RAIL DESIGN TO BE POST MOUNTED TO EXTERIOR SLAB AT TOP AND BOTTOM AND SHALL CONFORM TO THE REQUIRMENTS OF THE FLORIDA BUILDING CODE. ENTIRE SYSTEM TO BE PAINTED PER SPECIFICATIONS
- CONTRACTOR TO PROVIDE ENGINEERED SHOP DRAWINGS FOR APPROVAL PRIOR TO FABRICATION REFER TO DETAILS FOR ADDITIONAL INFORMATION DESTAIR GUARDRAIL AND HANDRAIL: 1.5" DIAMETER 42" HIGH GUARDRAIL WITH 1" DIAMETER VERTICAL PICKETS AT 4" O.C. 1.5" DIAMETER POSTS AS REQUIRED AND CONTINUOUS
- HANDRAIL AT 34 36" AFF. REFER TO STAIR DETAILS FOR ATTACHMENT METHODS. RAIL DESIGN TO CONFORM TO THE REQUIREMENTS OF THE FLORIDA BUILDING CODE. ENTIRE SYSTEM TO BE PAINTED PER SPECIFICATIONS. CONTRACTOR TO PROVIDE ENGINEERED SHOP DRAWINGS FOR APPROVAL PRIOR TO FABRICATION. REFER TO DETAILS AND ELEVATIONS FOR MORE INFORMATION 05RD ALUMINUM HANDRAIL: 2" DIAMETER CONTINUOUS HANDRAIL WITH OFFSET WALL BRACKETS EVENLY SPACED. RAIL DESIGN
- BUILDING CODE. ENTIRE SYSTEM TO BE PAINTED AS REQUIRED PER SPECIFICATIONS. CONTRACTOR TO PROVIDE ENGINEERED SHOP DRAWINGS FOR APPROVAL PRIOR TO FABRICATION. REFER TO DETAILS AND ELEVATIONS FOR MORE INFORMATION 05RE ALUMINUM BALCONY GUARDRAIL: 2" DIAMETER PAINTED ALUMINUM RAILING, 42" HIGH TOP RAIL WITH BOTTOM RAIL AT 4" AFF, VERTICAL SUPPORT POSTS SHALL BE EQUALLY
- SPACED AT 5'-0" O.C., CORE DRILLED INTO STRUCTURE, 1" DIAMETER VERTICAL PICKETS AT 4" O.C. RAIL DESIGN TO CONFORM TO THE REQUIREMENTS OF THE FLORIDA BUILDING CODE. GUARDRAIL TO BE PAINTED PER SPECIFICATIONS. CONTRACTOR TO PROVIDE ENGINEERED SHOP DRAWINGS FOR APPROVAL PRIOR TO FABRICATION. REFER TO DETAILS AND ELEVATIONS FOR MORE INFORMATION. 06A WOOD BLOCKING: ALL BLOCKING TO BE MIN. 3/4" FRT PLWOOD
- (MARINE GRADE IN WET AREAS). SCREW FASTEN BETWEEN METAL STUDS IN PARTITIONS AND FURRED WALLS, TYPICAL. 09E PAINT: PROVIDE PRIMER AND PAINT WITH SUFFICIENT COVERAGE, REFER TO SCHEDULE FOR COLORS AND SPECIFICATIONS FOR PROPER TYPE AND ADDITIONAL INFORMATION.
- 10E MAILBOXES: AMAZON LOCKER AND OR USPS LOCKABLE MAILBOXES. REFER TO SPECIFICATIONS FOR ADDITIONAL INFORMATION AND REFER TO ELECTRICAL DOCUMENTS FOR POWER AND DATA REQUIREMENTS
- 10F FIRE EXTINGUISHER CABINET; FULLY RECESSED WHERE ALLOWED. LARSEN "OCCULT SERIES"; 0-2409 SOLID DOOR; FLAT TRIM, ALUMINUM CABINET COLOR WHITE. REFER TO LIFE SAFETY DRAWINGS FOR EXTINGUISHER TYPE. 10G CORNER GUARD: PROVIDE METAL CORNER GUARDS AT ALL LOCATIONS TO PROTECT PIPING OR CONDUIT FROM VEHICLE
- 12A SHORT TERM BIKE PARKING: REFER TO LANDSCAPE AND CIVI FOR TYPE AND EXACT PLACEMENT, ANCHORED TO CONCRETE SLAB.
- 22H FIRE PROTECTION STANDPIPE: PROVIDE AND INSTALL TWO (1 1/2" DIAMETER HORIZONTAL PIPE RAILS WITH ATTACHMENT PLATES ANCHORED TO STAIR WALLS, SPANNING HORIZONTALLY (DIAGONALLY) FROM WALL TO WALL (ACROSS CORNER). MOUNT LOWER RAÍL AT 6" O.C. A.F.F. AND TOP RAIL ANCHORED 27" TO TOP A.F.F. REFER TO FIRE PROTECTION DRAWINGS FOR ADDITIONAL INFORMATION.

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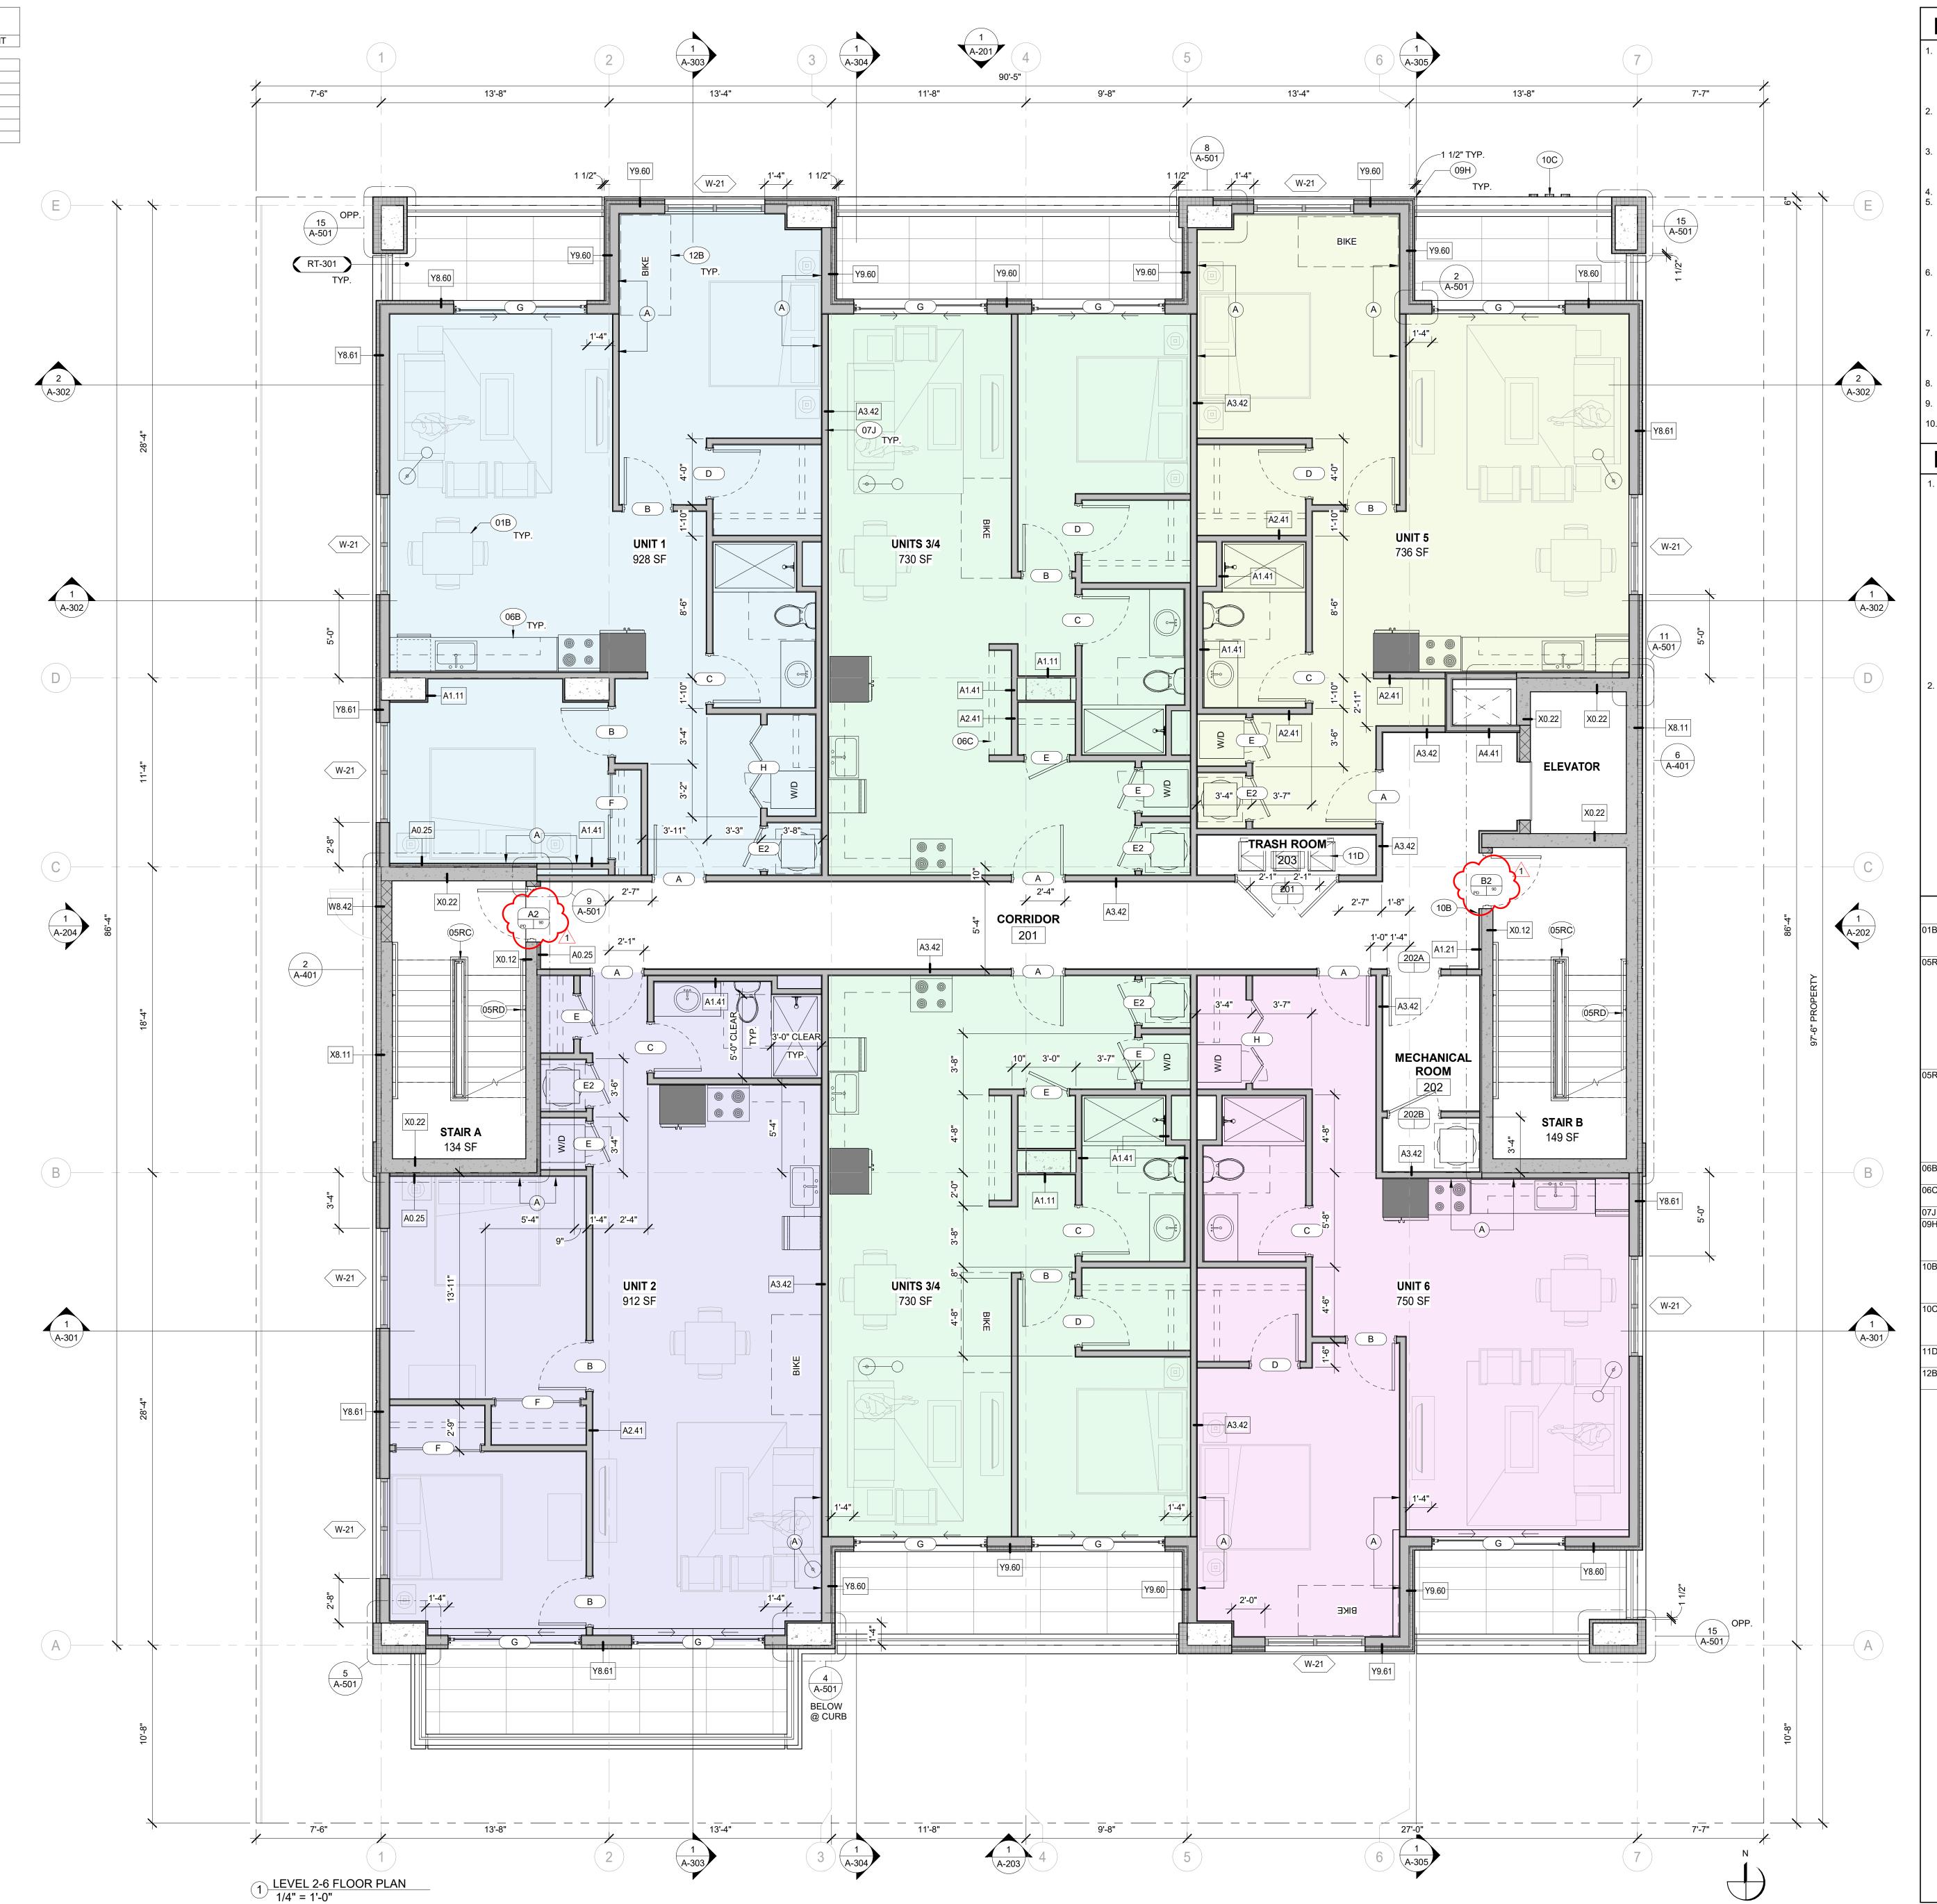
ISSUED DRAWING LOG: # DATE DESCRIPTION 1 03.24.2023 NOVA RESPONSE

PROJECT NUMBER: 22.030 ISSUE DATE:

03.01.2023 DRAWING TITLE: LEVEL 1 FLOOR PLAN

SHEET NUMBER:

EDITION:



UNIT TYPES AND AREA MATRIX

AREA

736 SF

750 SF

1096 SF

730 SF

579 SF

BED/BATH

2 BED / 1BATH

1 BED / 1 BATH

1 BED / 1 BATH

2 BED / 1BATH

1 BED / 1 BATH

1 BED / 1 BATH

UNITS 3/4

UNITS 8

TOTAL UNITS

PLAN GENERAL NOTES

BUILDING SIGNAGE SHALL BE PERMITTED SEPARATELY AND IS NOT INCLUDED IN CONTRACT (N.I.C). COORDINATE WORK WITH OWNER'S SIGNAGE VENDOR FOR ANTICIPATED SIGNAGE LOCATIONS AND ELECTRICAL REQUIREMENTS, PROVIDE POWER FOR FUTURE HOOKUP AT COORDINATED LOCATIONS IN RECESSED JUNCTION BOXES AND CONDUITS. ALL FIXTURES, FURNITURE, AND EQUIPMENT IS NOT INCLUDED IN CONTRACT (N.I.C) AND IS INDICATED FOR SUGGESTIVE REFERENCE ONLY TO SHOW COMPATIBILITY WITH REQUIRED CLEARANCES, POWER HOOKUPS, ETC. BIKE PARKING COMPLIANCE: EACH UNIT SHOWS THE CLEAR FLOOR SPACE FOR ONE LONG TERM BIKE SPARKING SPACE (33 TOTAL REQUIRED). 5 ADDITIONAL LONG TERM BIKE SPACES AND 2 SHORT TERM SPACES ARE SHOWN ON L1 BUILDING SHALL COMPLY WITH FHA REQUIREMENTS. CODE COMPLIANCE STATEMENT: TO THE BEST IF THE

4. BUILDING SHALL COMPLY WITH FHA REQUIREMENTS.
5. CODE COMPLIANCE STATEMENT: TO THE BEST IF THE ARCHITECT'S KNOWLEDGE, THESE PLANS AND SPECIFICATIONS COMPLY WITH THE APPLICABLE MINIMUM BUILDING CODES AND THE APPLICABLE FIRE-SAFETY STANDARDS AS DETERMINED BY THE LOCAL AUTHORITY IN ACCORDANCE WITH SECTION 110.8.4 OF 2020 FBC BUILDING 7TH EDITION AND CHAPTER 633 OF THE FLORIDA STATUES.
6. BUILDING COMPONENTS AND INFORMATION DEPICTED HEREIN FROM OTHER CONSULTANTS ARE INCLUDED FOR REFERENCE ONLY. COMPONENTS AND INFORMATION SHOWN MAY NOT BE ALL INCLUSIVE. REFER TO APPROPRIATE DISCIPLINE FOR COMPLETE INFORMATION ON THESE

SYSTEMS.
PROVIDE AND INSTALL FIRE RETARDANT SOLID WOOD
BLOCKING WITHIN WALL AS REQUIRED TO ANCHOR ALL
FIXTURES AND ACCESSORIES. G.C SHALL CLOSELY
COORDINATE ALL MOUNTING REQUIREMENTS PRIOR TO
INSTALLING FINAL WALL SHEATHING.

8. REFER TO I.D AND ELECTRICAL DRAWINGS FOR ALL LIGHT FIXTURE TYPES AND LOCATIONS.

9. REFER TO I.D. DRAWINGS FOR KITCHEN ISLAND, COUNTERTOP, AND EQUIPMENT DIMENSIONS.

10. MAINTAIN 3'-4" MIN. CLR. BETWEEN ISLAND AND FACE OF APPLIANCE OR OPPOSING COUNTERTOP AS OCCURS.

DIMENSION NOTES

- A. MASONRY PLAN DIMENSIONS ARE NOMINAL AT SCALES NOT SHOWING INDIVIDUAL MODULE.

 B. OPENINGS ARE NOMINAL MASONRY OPENINGS AT SCALES NOT SHOWING INDIVIDUAL MODULES.
- C. MASONRY COURSING LINES SHOWN IN ELEVATION REPRESENT NOMINAL DIMENSIONS. JOINT LINES ARE AT TOP OF MASONRY UNIT. VERTICAL JOINT LINES ARE AT CENTERLINE OF JOINT.
 D. EXTERIOR WALL DIMENSIONS ARE MEASURED TO STRUCTURAL GRIDLINE OR FACE, OR FACE OF STRUCTURAL WALL, U.N.O.
- E. WHERE FRAMED OPENINGS, DOOR OPENINGS, WINDOW OPENINGS ARE DIRECTLY ADJACENT TO PERPENDICULAR WALLS, DIMENSION FROM FACE OF WALL TO EDGE OPENING SHALL BE 8 INCHES, U.N.O. A MINIMUM HEADER BEARING OF 8- INCHES SHALL BE PROVIDED AT ALL MASONRY OPENINGS.

 F. DRAWINGS WITH INDIVIDUAL MODULAR UNITS SHOWN ARE DIMENSIONED TO ACTUAL SIZE.
- A. A STUD WALL DIMENSIONS ARE FROM FACE OF STUD TO FACE OF STUD, OR FACE OF STUD TO FACE OF MASONRY/CONCRETE OR LAYOUT LINE AS OCCURS.
 B. ALL CORNERS ARE AT 90 DEGREE RIGHT ANGLES (PERPENDICULAR) TO OTHER WALLS, UNLESS NOTED

METAL STUDS:

- OTHERWISE (U.N.O.).

 C. WHERE DOORS ARE ADJACENT TO PERPENDICULAR WALLS, DIMENSION FROM FACE OF WALL TO EDGE OF ERAME SHALL BE 4 INCHES LIN O
- WALLS, DIMENSION FROM FACE OF WALL TO EDGE OF FRAME SHALL BE 4 INCHES, U.N.O.

 D. ELEMENTS POSITION BASED ON NON PARALLEL OR NON PERPENDICULAR RELATIONSHIPS TO OTHER ELEMENTS SHALL BE PLACED BY THE WORK POINTS DEFINED FROM
- OTHER ELEMENTS.

 E. RADIUS ELEMENTS DEFINED BY MORE THAN 2 WORK POINTS SHALL BE PLACED BY STRIKING AN ARC TANGENT TO ALL WORK POINTS. WHERE MORE THAN 3 WORK POINTS ARE PRESENT, THE ARC AT EACH WORK POINT SHALL BE TANGENT TO THE ADJACENT WORK POINT ON EACH SIDE.

KEYNOTE LEGEND

- 01B INTERIOR DESIGN SCOPE SHOWN FOR REFERENCE ONLY.
 REFER TO INTERIOR DESIGN DOCUMENTS FOR
 ADDITIONAL INFORMATION.
- OSRC

 STAIR GUARDRAIL AND HANDRAIL: 1.5" DIAMETER 42" HIGH GUARDRAIL WITH 1" DIAMETER VERTICAL PICKETS AT 4" O.C., 1.5" DIAMETER POSTS AS REQUIRED AND CONTINUOUS HANDRAIL AT 34 36" AFF. REFER TO STAIR DETAILS FOR ATTACHMENT METHODS. RAIL DESIGN TO CONFORM TO THE REQUIREMENTS OF THE FLORIDA BUILDING CODE. ENTIRE SYSTEM TO BE PAINTED PER SPECIFICATIONS. CONTRACTOR TO PROVIDE ENGINEERED SHOP DRAWINGS FOR APPROVAL PRIOR TO FABRICATION. REFER TO DETAILS AND ELEVATIONS FOR MORE INFORMATION
 - ALUMINUM HANDRAIL: 2" DIAMETER CONTINUOUS HANDRAIL WITH OFFSET WALL BRACKETS EVENLY SPACED. RAIL DESIGN TO CONFORM TO THE REQUIREMENTS OF THE FLORIDA BUILDING CODE. ENTIRE SYSTEM TO BE PAINTED AS REQUIRED PER SPECIFICATIONS. CONTRACTOR TO PROVIDE ENGINEERED SHOP DRAWINGS FOR APPROVAL PRIOR TO FABRICATION. REFER TO DETAILS AND ELEVATIONS FOR MORE INFORMATION
- INFORMATION

 B CASEWORK: REFER TO INTERIOR DESIGN DETAILS AND ELEVATIONS

 C MILLWORK: REFER TO INTERIOR DESIGN DETAILS AND
- BATT INSULATION: FULLY FILL WALL CAVITY

 H BALCONY DRAINAGE REVEAL: CONCRETE CURB AND EIFS
 SYSTEM PULLED BACK TO CREATE 1 1/2" CHANNEL. REFER
 TO PLANS, ELEVATIONS, AND DETAILS FOR ADDITIONAL
 INFORMATION.
- B SIGNAGE: ADA AND FBC COMPLIANT SIGNAGE, CAD CUT ACRYLIC W/ RAISED BRAILLE ALL RESTROOMS, ELECTRICAL, ELEVATOR AND FIRE EGRESS DOORS AS REQUIRED BY NFPA AND FBC.

 C SIGNAGE: TENANT/ BUILDING SIGNAGE UNDER SEPARATE SCOPE OF WORK, CONTRACTOR TO PROVIDE BACKING,

UNIT FOR BIKE PARKING

POWER, AND COORDINATION FOR INSTALLATION AS NEEDED.

D RECYCLING OR TRASH BIN: OWNER TO COORDINATE WITH THE MUNICPALITY FOR THE PROPER SIZES AND TYPES.

B LONG TERM BICYCLE STORAGE: SPACE DESIGNATED IN

Peterane TURE | INTERIC

ARC ARC (727) 800-53(

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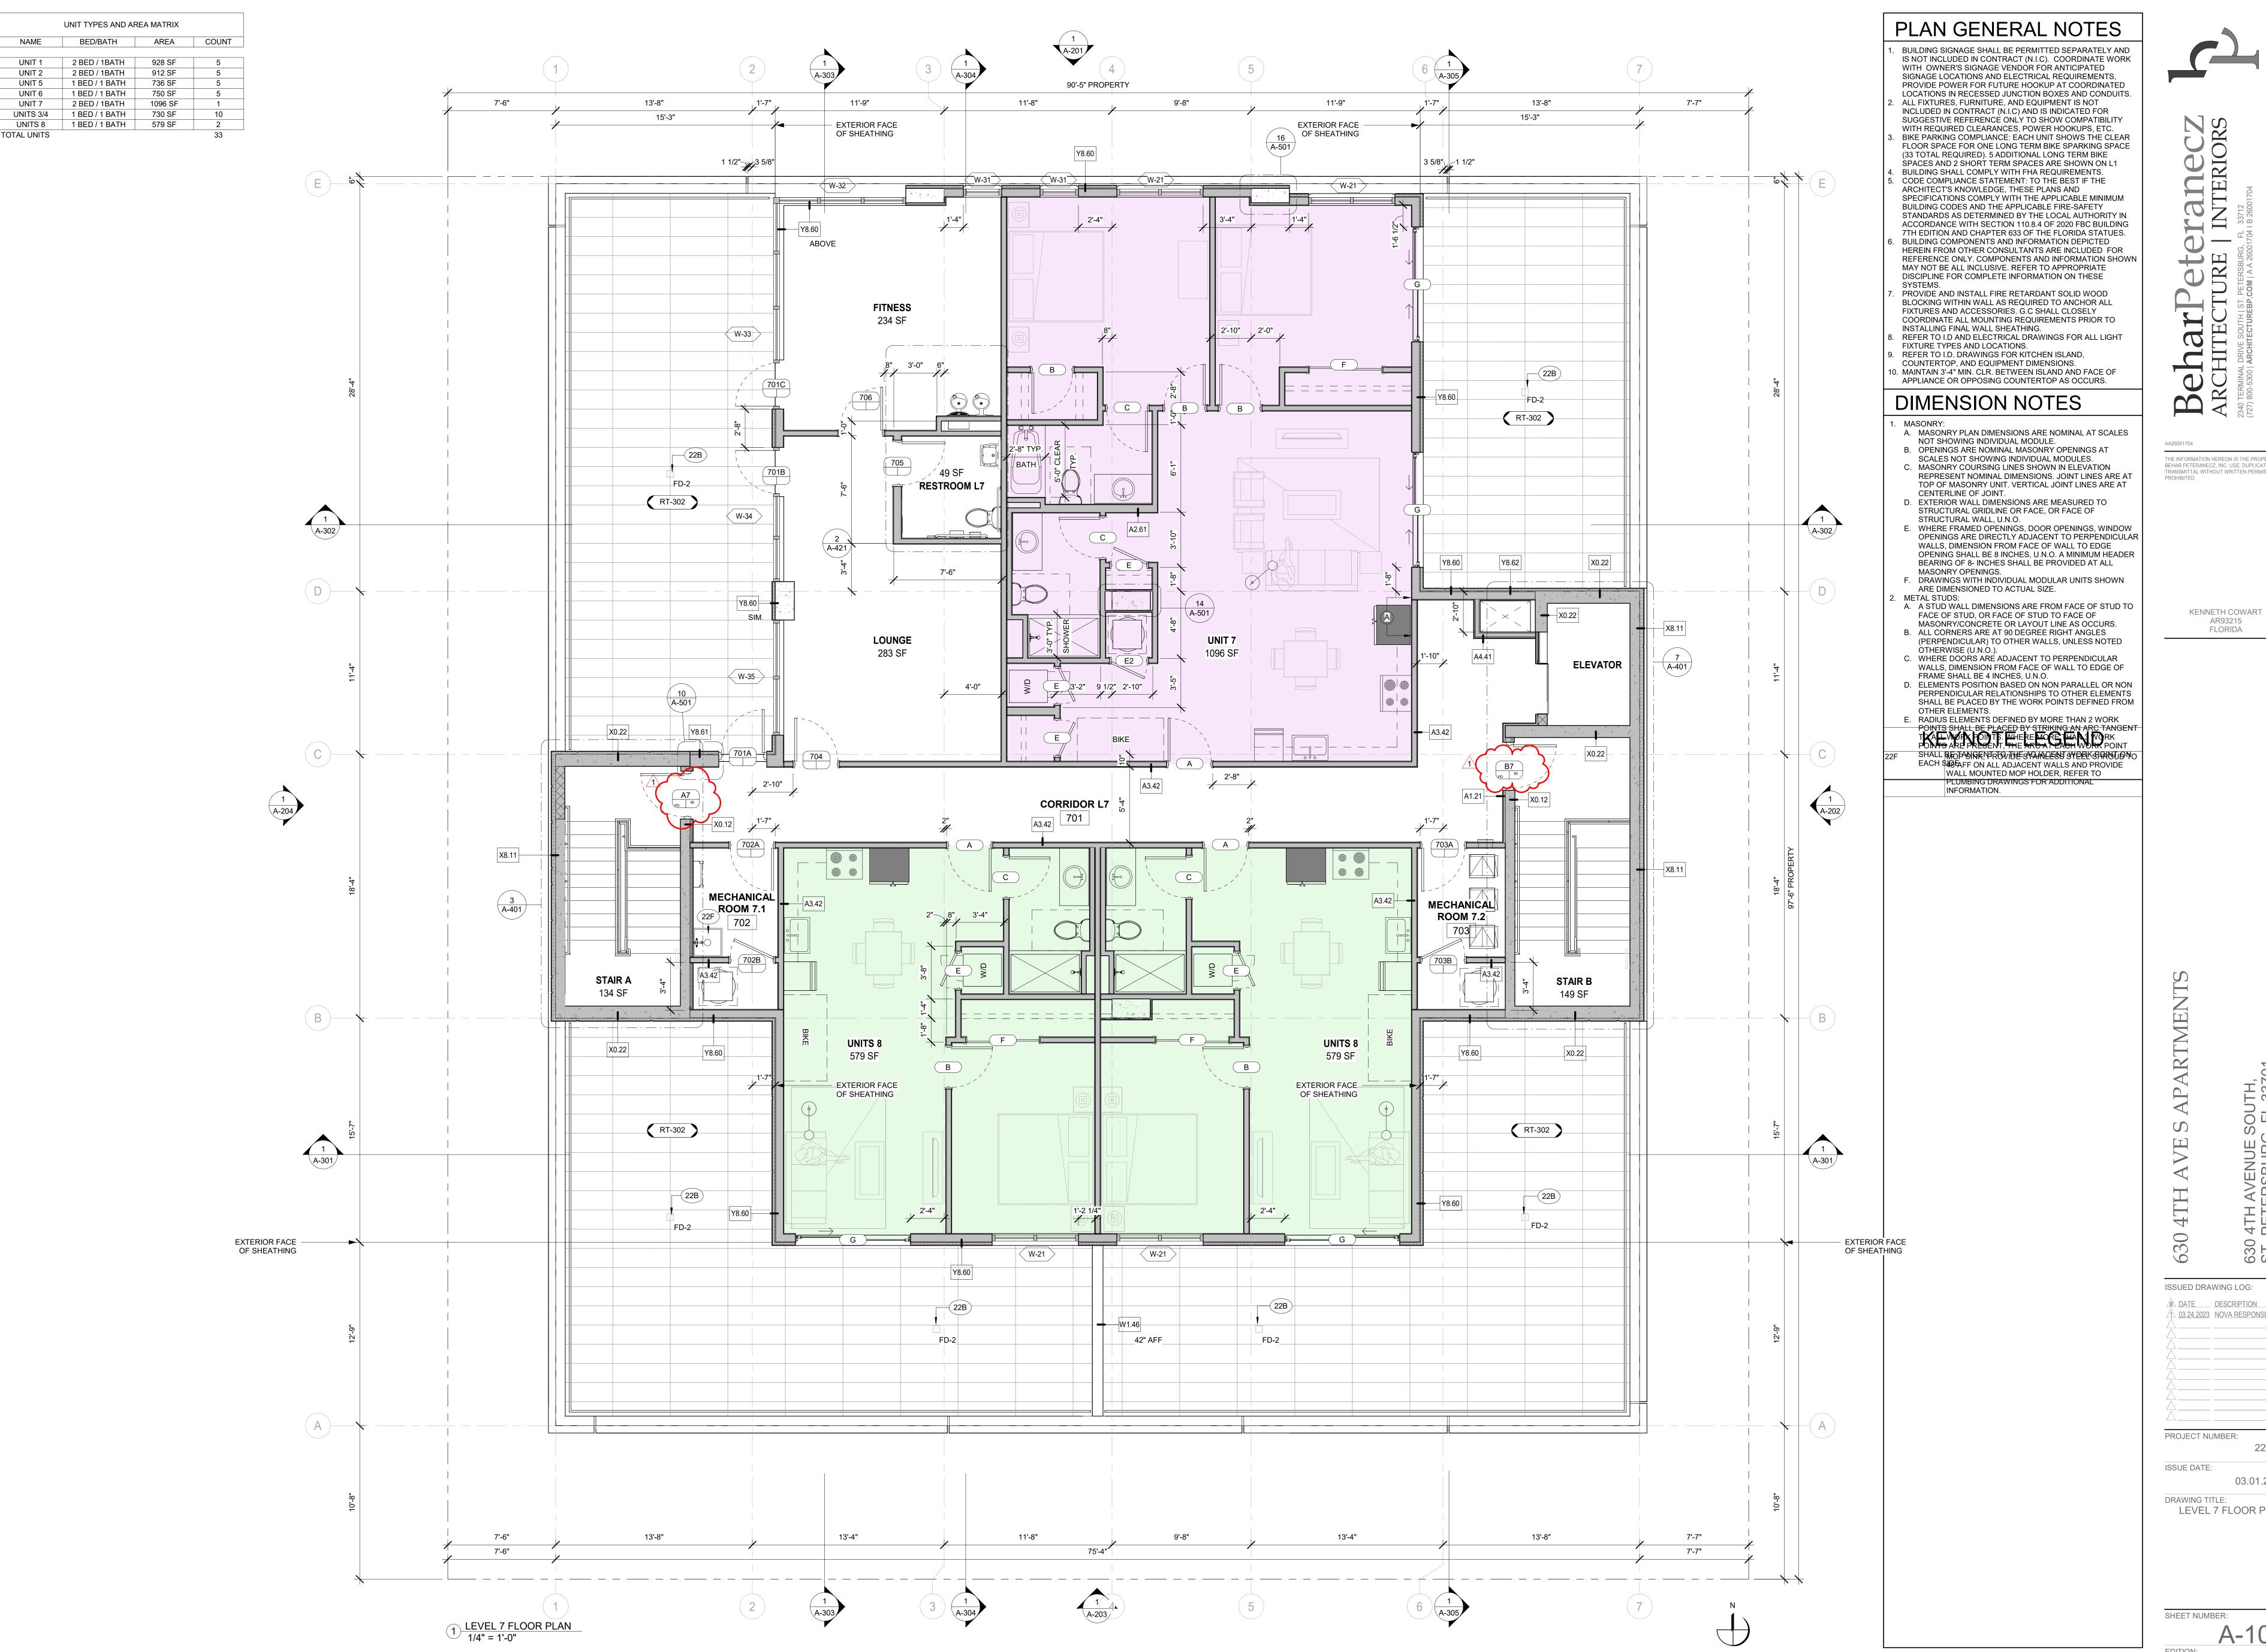
KENNETH COWART AR93215 FLORIDA

VENUE SOUTH,

ECT NUMBER: 22.030

DRAWING TITLE:
LEVEL 2-6 FLOOR PLAN

SHEET NUMBER:
A-102





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1 03.24.2023 NOVA RESPONSE

ISSUE DATE:

03.01.2023 DRAWING TITLE: LEVEL 7 FLOOR PLAN

SHEET NUMBER:



SHEET NUMBER:

A-201

EDITION:



KEYNOTE LEGEND

OSRE ALUMINUM BALCONY GUARDRAIL: 2" DIAMETER PAINTED ALUMINUM RAILING, 42" HIGH TOP RAI

ALUMINUM BALCONY GUARDRAIL: 2" DIAMETER PAINTED ALUMINUM RAILING, 42" HIGH TOP RAIL WITH BOTTOM RAIL AT 4" AFF, VERTICAL SUPPORT POSTS SHALL BE EQUALLY SPACED AT 5'-0" O.C., CORE DRILLED INTO STRUCTURE. 1" DIAMETER VERTICAL PICKETS AT 4" O.C. RAIL DESIGN TO CONFORM TO THE REQUIREMENTS OF THE FLORIDA BUILDING CODE. GUARDRAIL TO BE PAINTED PER SPECIFICATIONS. CONTRACTOR TO PROVIDE ENGINEERED SHOP DRAWINGS FOR APPROVAL PRIOR TO FABRICATION. REFER TO DETAILS AND ELEVATIONS FOR MORE INFORMATION.

EIFS STUCCO FINISH REVEAL: REFER TO MANUFACTURER GUIDELINES FOR ADDITIONAL INFORMATION

MANUFACTURER GUIDELINES FOR ADDITIONAL INFORMATION

BALCONY DRAINAGE REVEAL: CONCRETE CURB AND EIFS SYSTEM PULLED BACK TO CREATE 1 1/2"
CHANNEL. REFER TO PLANS, ELEVATIONS, AND DETAILS FOR ADDITIONAL INFORMATION.

RIDA R D AND

Behal Peteranecz

ARCHITECTURE | INTERIORS

(727) 800-5300 | ARCHITECTUREBROOM | A A 26001704 | B 26001704

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30 4TH AVE S APARTMENTS

ISSUED DRAWING LOG:

A DATE DESCRIPTION

PROJECT NUMBER:

ISSUE DATE: 03.01.2023

DRAWING TITLE:
EXTERIOR ELEVATIONS

1) SOUTH ELEVATION 1/4" = 1'-0"

HEET NUMBER:

A-203

DITION:

KEYNOTE LEGEND

EIFS STUCCO FINISH REVEAL: REFER TO MANUFACTURER GUIDELINES FOR ADDITIONAL INFORMATION BALCONY DRAINAGE REVEAL: CONCRETE CURB AND EIFS SYSTEM PULLED BACK TO CREATE 1 1/2" CHANNEL. REFER TO PLANS, ELEVATIONS, AND DETAILS FOR ADDITIONAL INFORMATION.

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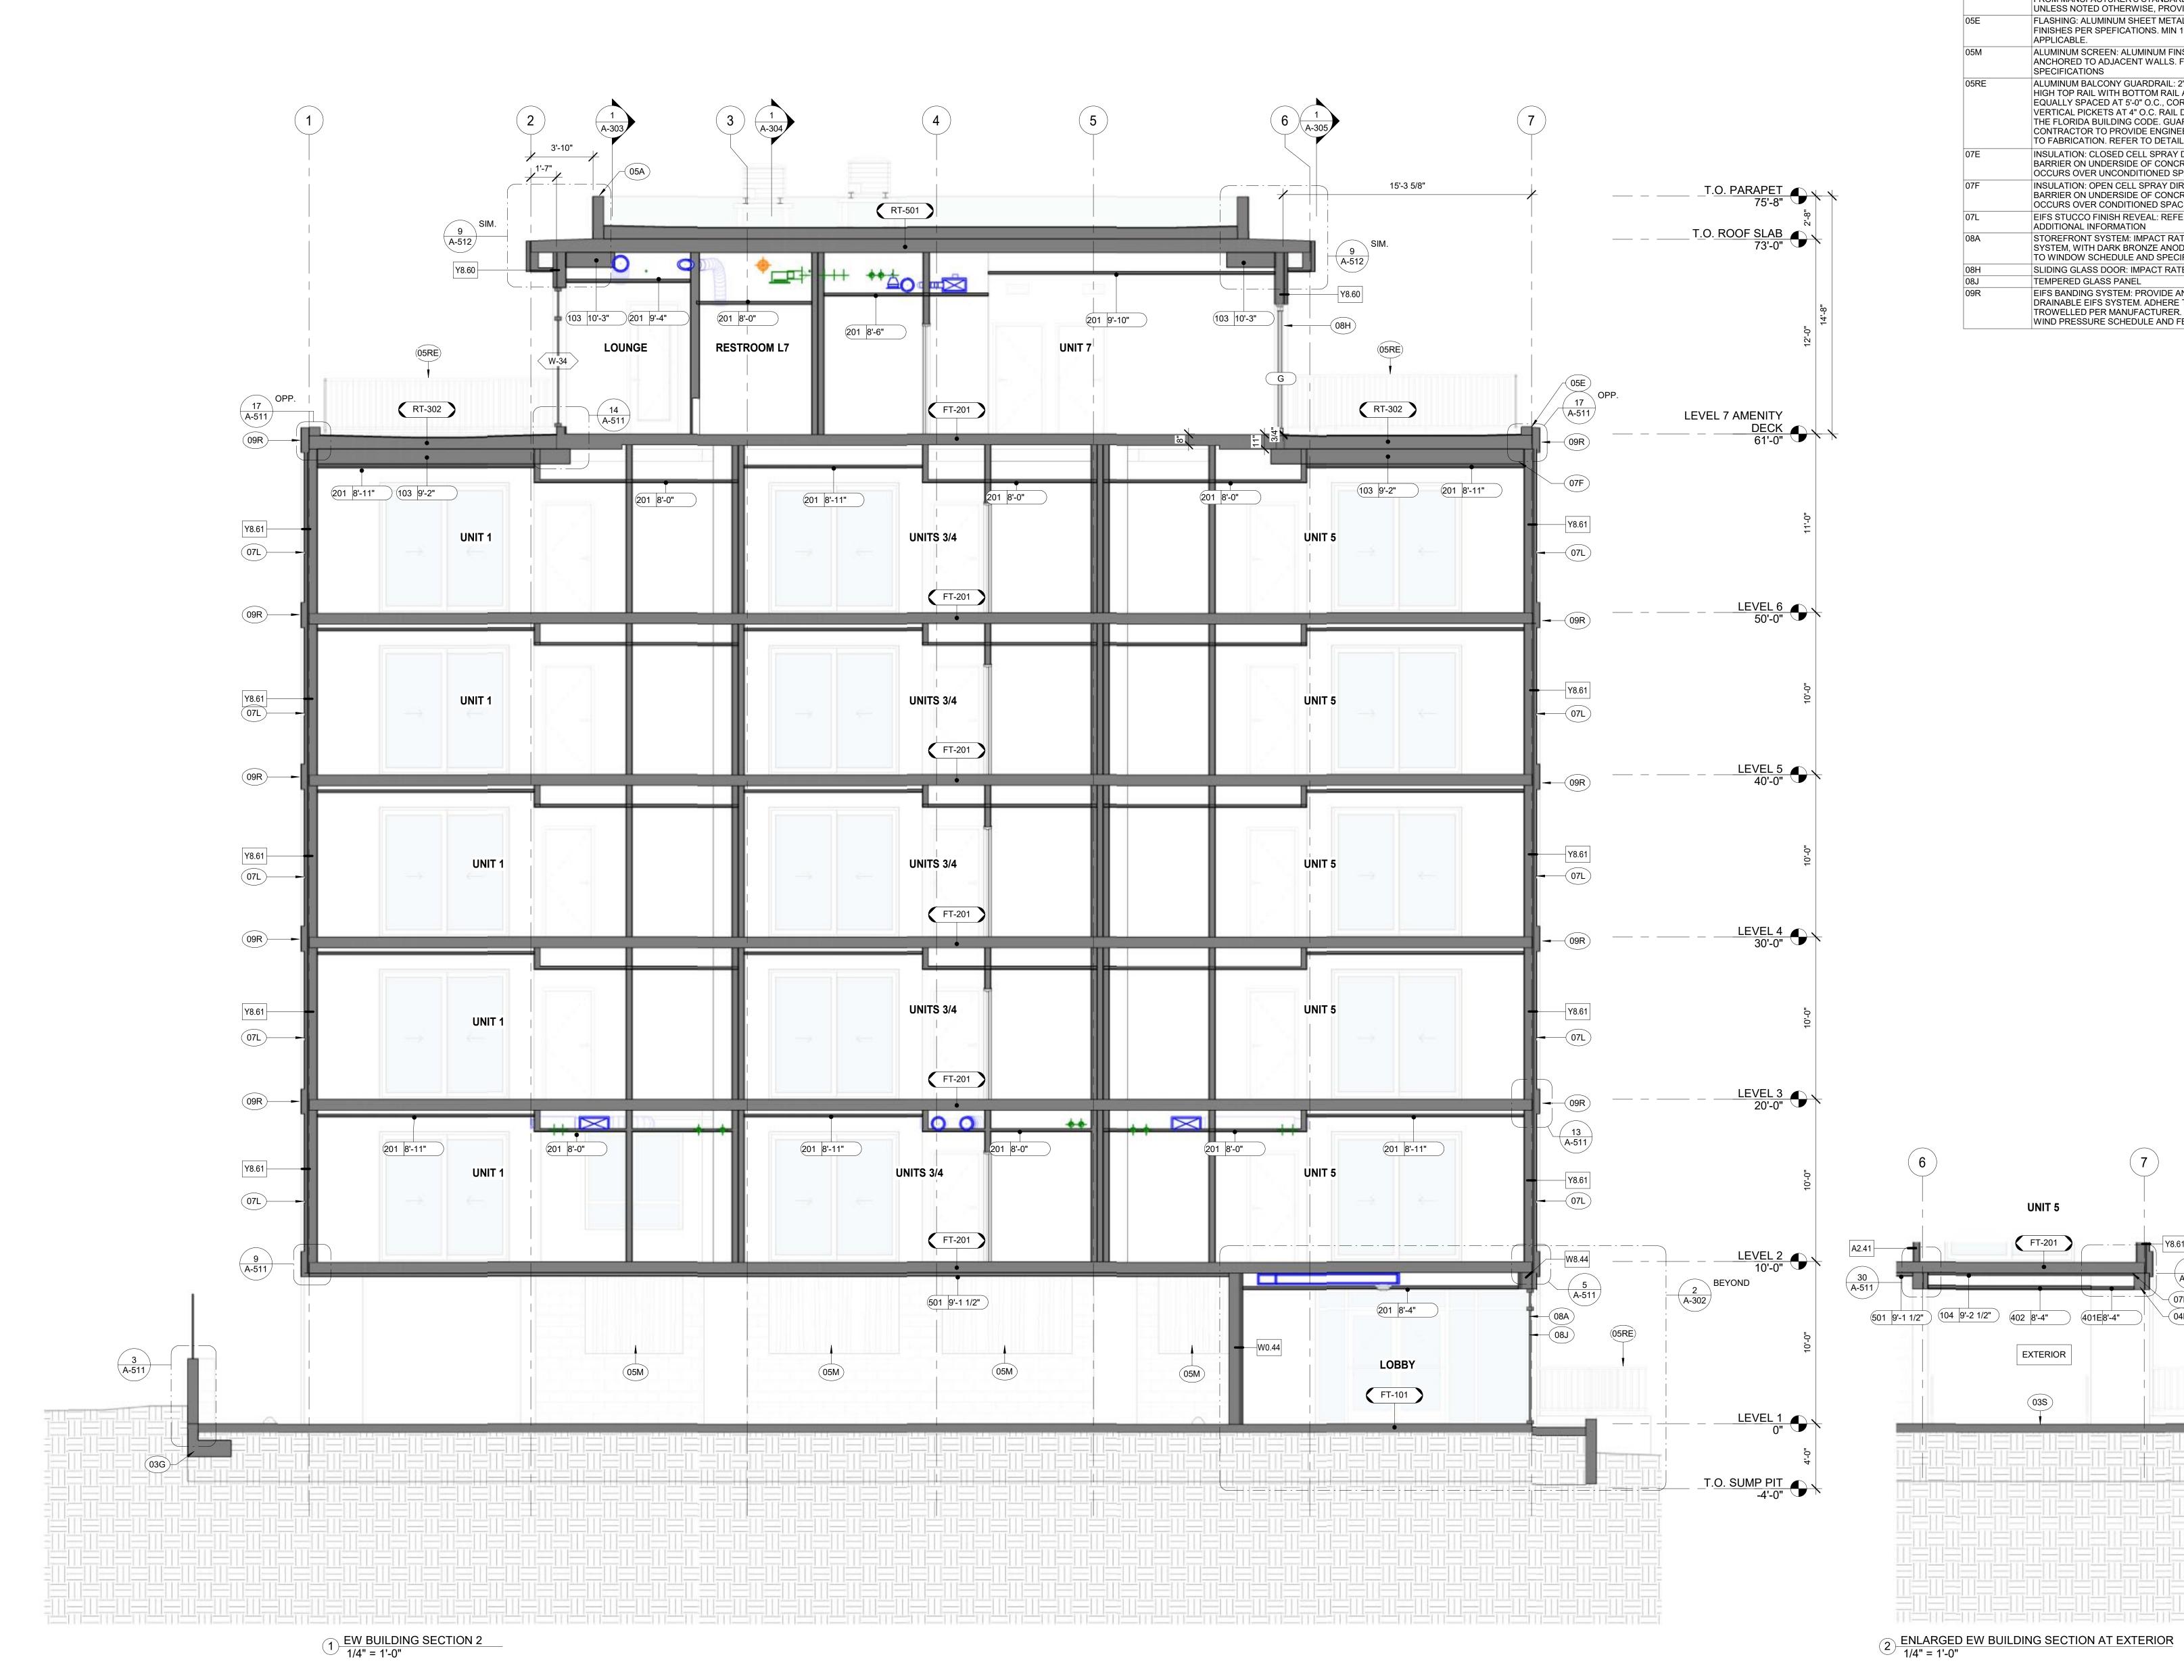
ISSUED DRAWING LOG:

630 4TH AVENUE SOUTH, ST. PETERSBURG, FL 33701

PROJECT NUMBER:

ISSUE DATE:

03.01.2023 DRAWING TITLE:
EXTERIOR ELEVATIONS



KEYNOTE LEGEND CONCRETE FOOTER, FOUNDATION, OR PILE CAP: REFER TO STRUCTURAL DRAWINGS FOR ADDITIONAL INFORMATION EXTERIOR CONCRETE SLAB: REFER TO CIVIL AND LANDSCAPE DRAWINGS FOR ADDITIONAL INFORMATION PRECAST MASONRY LINTEL OR BOND BEAM: GROUT FILLED U BLOCK LINTEL W/ REBAR, REFER STRUCTURAL DRAWINGS FOR ADDITIONAL INFORMATION. CONCRETE MASONRY RETAINING WALL: REFER TO STRUCTURAL DRAWINGS FOR ADDITIONAL INFORMATION. WHERE LEFT EXPOSED THE CMU SHALL BE LEVEL, PLUMB AND CLEAN OF ALL EXCESS GROUT, GROUT LINES TO BE UNIFORM AND CONCAVE, FINISH WITH HYDROPHOBIC PAINT ALUMINUM PARAPET CAP FLASHING SYSTEM: MINIMUM 16 GA, FACTORY PAINTED FROM MANUFACTURER'S STANDARD COLORS. COLOR TO MATCH ADJACENT WALL UNLESS NOTED OTHERWISE, PROVIDE COLOR SUBMITTAL PRIOR TO FABRICATION. FLASHING: ALUMINUM SHEET METAL FLASHING, PAINTED TO MATCH ADJACENT FINISHES PER SPEFICATIONS. MIN 16 GA. SET IN CONTINUOUS SEALANT WHERE APPLICABLE. ALUMINUM SCREEN: ALUMINUM FINS. WELDED TO CONTINUOUS ALUMINUM FRAME ANCHORED TO ADJACENT WALLS. FINS AND FRAME TO BE PAINTED PER SPECIFICATIONS ALUMINUM BALCONY GUARDRAIL: 2" DIAMETER PAINTED ALUMINUM RAILING, 42" HIGH TOP RAIL WITH BOTTOM RAIL AT 4" AFF, VERTICAL SUPPORT POSTS SHALL BE EQUALLY SPACED AT 5'-0" O.C., CORE DRILLED INTO STRUCTURE. 1" DIAMETER VERTICAL PICKETS AT 4" O.C. RAIL DESIGN TO CONFORM TO THE REQUIREMENTS OF THE FLORIDA BUILDING CODE. GUARDRAIL TO BE PAINTED PER SPECIFICATIONS. CONTRACTOR TO PROVIDE ENGINEERED SHOP DRAWINGS FOR APPROVAL PRIOR TO FABRICATION. REFER TO DETAILS AND ELEVATIONS FOR MORE INFORMATION. INSULATION: CLOSED CELL SPRAY DIRECT APPLIED INSULATION WITH IGNITION BARRIER ON UNDERSIDE OF CONCRETE DECK WHERE CONDITIONED SPACE OCCURS OVER UNCONDITIONED SPACE. INSULATION: OPEN CELL SPRAY DIRECT APPLIED INSULATION WITH IGNITION BARRIER ON UNDERSIDE OF CONCRETE DECK WHERE UNCONDITIONED SPACE OCCURS OVER CONDITIONED SPACE. EIFS STUCCO FINISH REVEAL: REFER TO MANUFACTURER GUIDELINES FOR ADDITIONAL INFORMATION STOREFRONT SYSTEM: IMPACT RATED, 5" DEEP ALUMINUM EXTERIOR STOREFRONT SYSTEM, WITH DARK BRONZE ANODIZED FRAME UNLESS NOTED OTHERWISE. REFER TO WINDOW SCHEDULE AND SPECIFICATIONS FOR ADDITIONAL INFORMATION SLIDING GLASS DOOR: IMPACT RATED SLIDING GLASS DOOR SYSTEM. TEMPERED GLASS PANEL EIFS BANDING SYSTEM: PROVIDE AND INSTALL DRYVIT OR APPROVED EQUAL DRAINABLE EIFS SYSTEM. ADHERE TO SUBSTRATE WITH BASE COAT VERTICALLY TROWELLED PER MANUFACTURER. ADHESION SHALL CONFORM TO STRUCTURAL WIND PRESSURE SCHEDULE AND FBC REQUIREMENTS.

EXTERIOR

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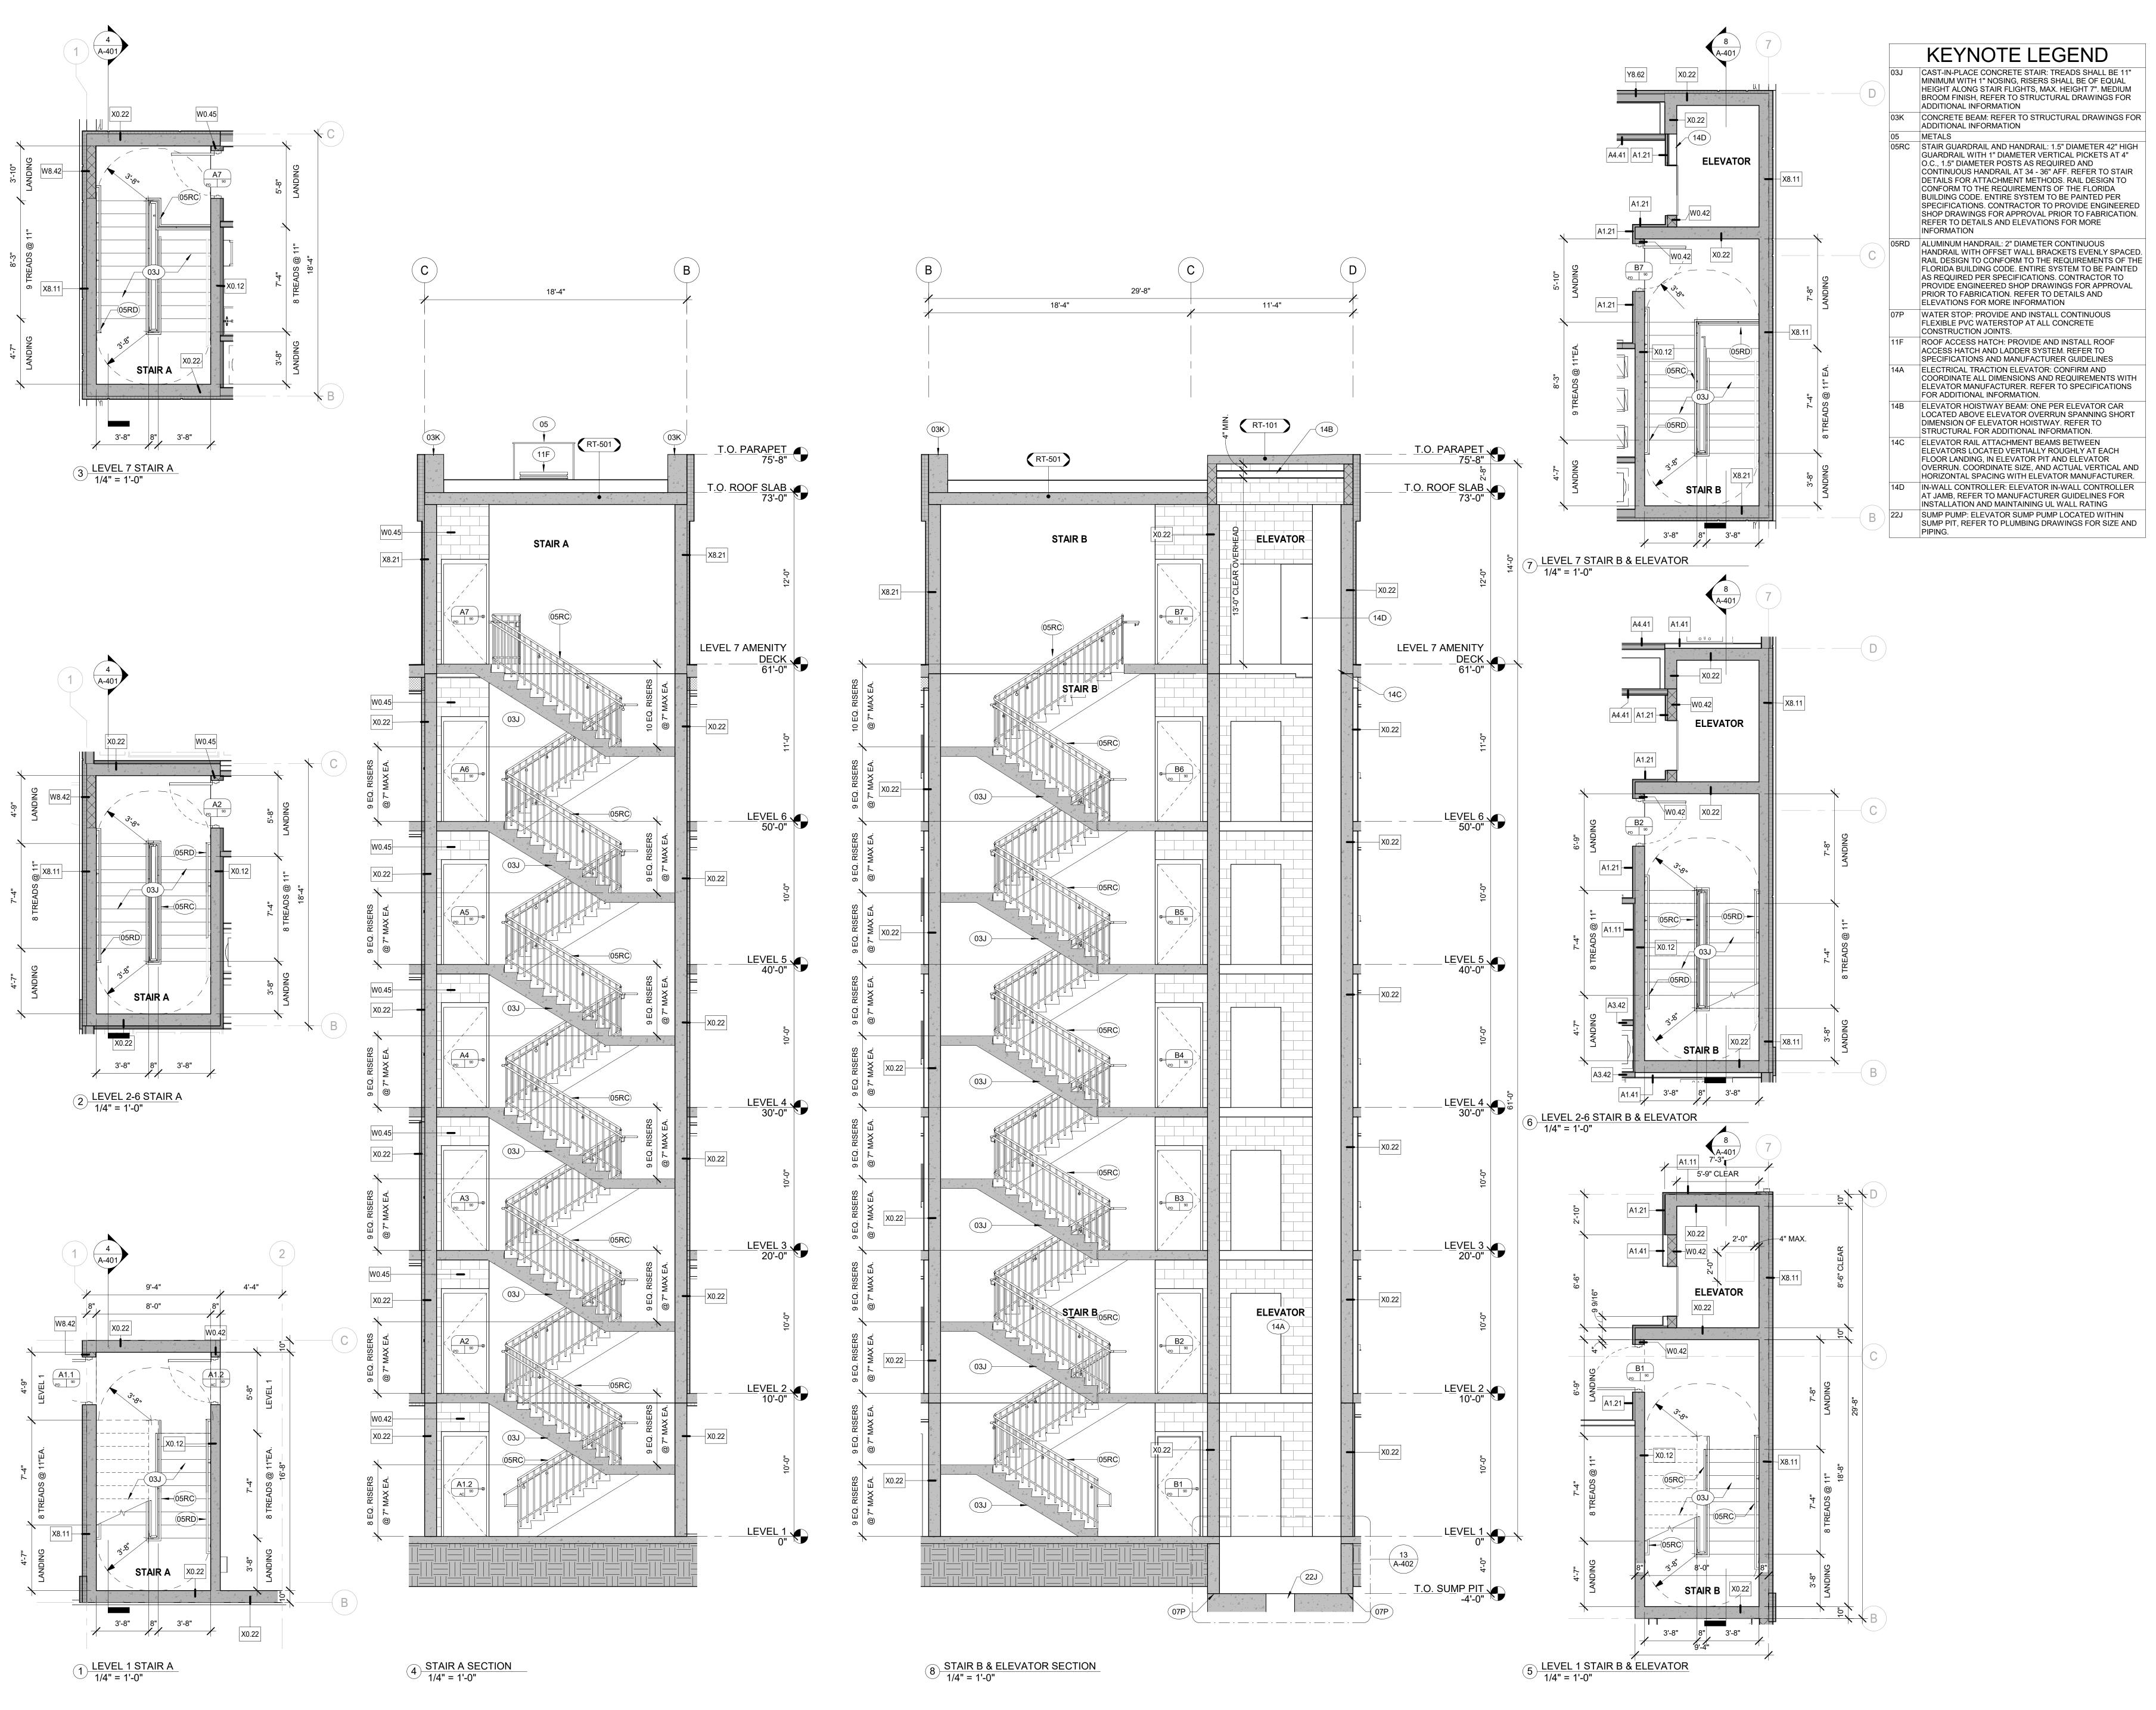
KENNETH COWART AR93215 FLORIDA

ISSUED DRAWING LOG:

T.O. BOH -2'-0"

ISSUE DATE: 03.01.2023

DRAWING TITLE:
BUILDING SECTIONS



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ISSUED DRAWING LOG:

PROJECT NUMBER: 22.030 ISSUE DATE: 03.01.2023

DRAWING TITLE:
ENLARGED STAIR AND
ELEVATOR

SHEET NUMBER: A-401 EDITION: